


# COMMONWEALTH OF KENTUCKY DEPARTMENT OF HIGHWAYS


PLANS OF PROPOSED PROJECT



# HENDERSON COUNTY US 41

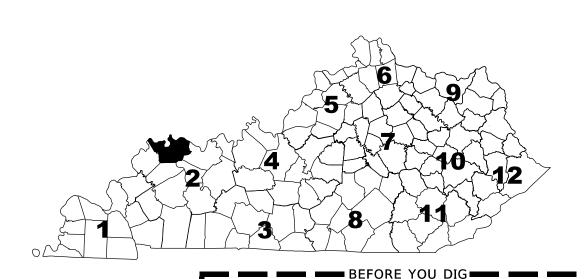

The contractor is instructed to call 1-800-752-6007 to reach KY 811, the one-call system for information on the location of existing underground utilities. The call is to be placed a minimum of two (2) and no more than ten (10) business days prior to excavation. The contractor should be aware that owners of underground facilities are not required to be members of the KY 811 one-call Before-U-Dig (BUD) service. The contractor must coordinate excavation with the utility owners, including those whom do not subscribe to KY 811. It may be necessary for the contractor to contact the County Court Clerk to determine what utility companies have facilities in the area. utility companies have facilities in the area.

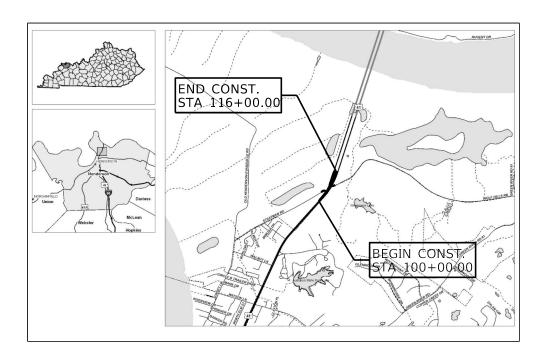



# LAYOUT MAP

### CLASS OF HIGHWAY STATE PRIMARY LEVEL TYPE OF TERRAIN DESIGN SPEED REQUIRED NPSD REQUIRED PSD LEVEL OF SERVICE ADT PRESENT ( ADT FUTURE ( DHV X

DESIGN CRITERIA

### GEOGRAPHIC COORDINATES

LATITUDE 37 DEGREES 53 MINUTES 23 SECONDS NORT LONGITUDE 87 DEGREES 33 MINUTES 25 SECONDS WEST

### **DESIGNED**

% RESTRICTED SD X LEVEL OF SERVICE X MAX. DISTANCE W/O PASSING

### **INDEX OF SHEETS**

LAYOUT SHEET
TYPICALS SECTIONS
SUMMARIES
PLAN SHEETS
GEOMETRIC DATA SHEET
DETAIL SHEETS
SHEETING SIGNS DETAIL SHEETS
SIGNING PLAN SHEETS
STRIPING SHEETS
STRIPING SHEETS R001 R002-R003 R004-R007 R008-R010 R011 R012-R017 R018-R024 R025-R027 R028-R030 X0031-X040 CROSS SECTIONS

### STANDARD DRAWINGS

RPM-001-04 RGX-005-06 RPM-010-06 RGX-065-03 RPM-100-11 RPM-115-05

### LENGTH 1600.00 LIN. FT. <u>0.30</u> ADDED FOR EQUALITIES \_

DDED FOR EQUALITIES NOT INCLUDED RAILROAD CROSSINGS NO. 0 RAILROAD CROSSINGS NO. \_\_\_\_

### FOR EQUALITIES NOT INCLUDED AILROAD CROSSINGS NO. \_\_\_

\_ LIN. F

FOR EQUALITIES \_\_\_ NOT INCLUDE RAILROAD CROSSINGS NO.

MILES	
1 11223	
LIN. FT.	
0	
LIN. FT.	
LIN. FT.	

WSP USA Inc. 1792 ALYSHEBA WAY SUITE 230 LEXINGTON, KY 4050

PROJECT NUMBER: FD52 051 0041 018-019


PROJECT DESCRIPTION: US 41 - WOLF HILLS ROAD INTERSECTION

LETTING DATE:	Х		
ITEM NO. 02-0935.00		COUNTY OF HENDERSON	
SHEET NO.			


OpenRoads Designer v10.16.2.267

FILE NAME: C:\USERS\USTJ725830\DOCUMENTS\HSIP\HENDERSON RCUT\DGN\SHEETS\R1 - LAYOUT SHEET.DGN


# TYPICAL SECTIONS

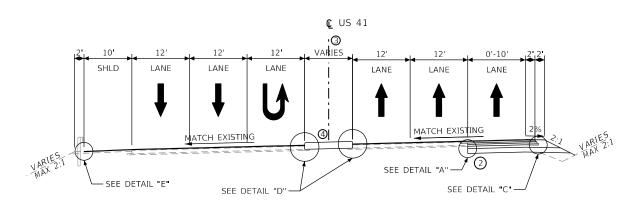


US 41 STA 100+40 TO STA 101+85 SUPERELEVATED SECTION

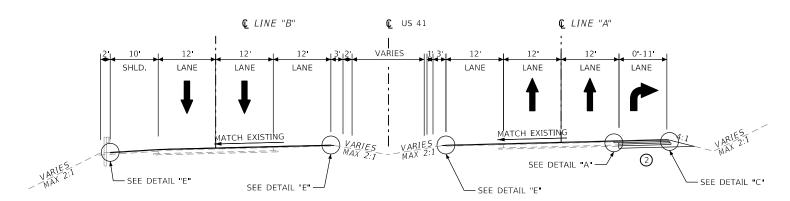

US 41 STA 107+46 TO STA 108+67 SUPERELEVATED SECTION

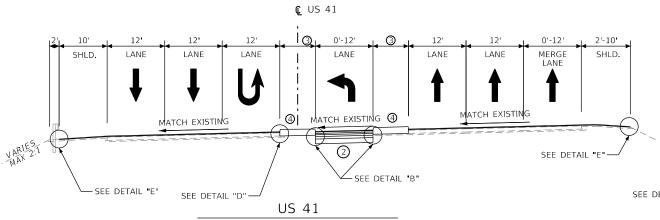


STA 101+85 TO STA 105+78 SUPERELEVATED SECTION

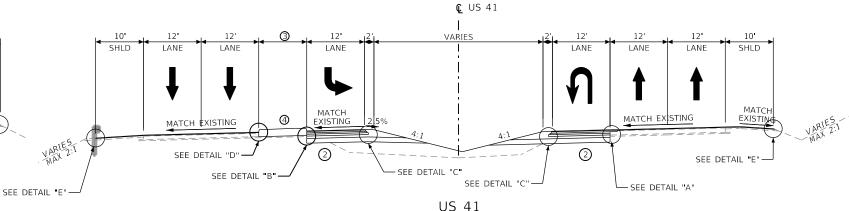

STA 108+67 TO STA 110+92 SUPERELEVATED SECTION


- 1 FOR FULL DEPTH PAVEMENT LONGITUDINAL JOINTS, PERFORM ASPHALT PAVE MILLING & TEXTURING A TOTAL DEPTH OF 5.00 INCHES (AN ADDITIONAL 3.5" REQUIRED FOR MILL AND OVERLAY) AND A WIDTH OF 18.00 INCHES FROM EXISTING EDGE OF PAVEMENT FOR PAVEMENT TIE IN. SEE DETAIL "A". WILL BE PAID BY MILLING AND PAVING BID ITEMS.
- ② FULL DEPTH PAVEMENT SHALL HAVE A ROADBED OF 12.00" CRUSHED AGGREGATE SIZE NO 2 UNDERLAIN WITH FABRIC GEOTEXTILE CLASS 1A AND OVERLAIN WITH FABRIC GEOTEXTILE CLASS 1.
- 3 GORE AREA WIDTH VARIES
- (4) MOUNTABLE MEDIAN TYPE 3 OR STANDARD BARRIER MEDIAN TYPE 4 SEE PLANS FOR LOCATIONS
- 5 CONTRACTOR SHALL DAYLIGHT CRUSHED STONE BASE SHOULDERS TO MEET EXISTING SLOPES.
- 6 AT LOCATIONS WHERE A RAISED CONCRETE MEDIAN IS TO BE INSTALLED WITH MILLING AND OVERLAY OF EXISTING PAVEMENT, EXISTING PAVEMENT SHALL BE SAWCUT TO A DEPTH OF 8.00 INCHES, OR THE FULL DEPTH OF EXISTING PAVEMENT, WHICHEVER IS LESS.
- 7 ASPHALT SEAL REQUIRED FROM OUTSIDE EDGE OF PAVED SHOULDER TO A POINT 2 FEET DOWN THE DITCH LINE OR FILL SLOPE. TWO APPLICATIONS OF THE FOLLOWING: ASPHALT SEAL COAT @ 2.40 LBS./SQ. YD. ASPHALT SEAL AGGREGATE @ 20 LBS/SQ. YD.

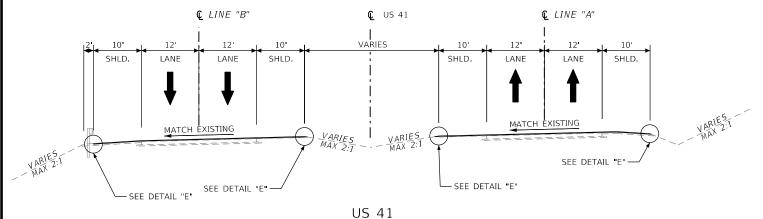


STA 105+78 TO STA 107+46 STA 115+03 TO STA 115+50 SUPERELEVATED SECTION

HENDERSON

# TYPICAL SECTIONS

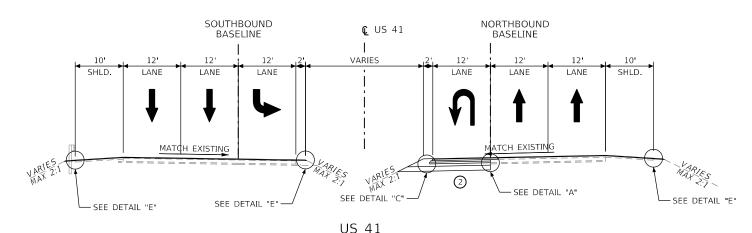


STA 110+92 TO STA 115+03 SUPERELEVATED SECTION

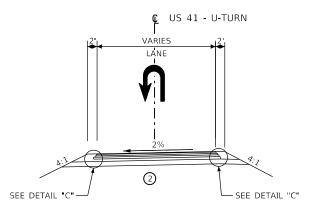


US 41 - U-TURN


STA 113+70 TO STA 114+50

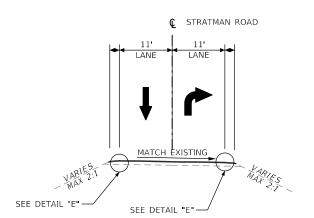


STRATMAN ROAD
STA 201+39 TO STA 202+84

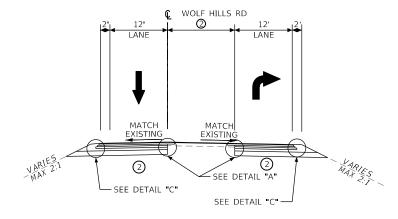

WOLF HILLS ROAD
STA 300+60 TO STA 301+80

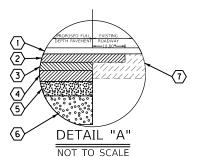


- 1.50" CL4 ASPH SURF 0.50A PG64-22 W/ FIBERS (PAID FOR BY FD05)
- ② 3.50" CL4 ASPH BASE 1.00D PG64-22
- 3 3.50" CL4 ASPH BASE 1.00D PG64-22
- 4.50" CL4 ASPH BASE 1.00D PG64-22 5 6.00" CRUSHED STONE BASE
- 2) 6 12.00" CRUSHED AGGREGATE NO. 2 7 EXISTING PAVEMENT

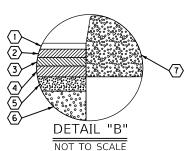


- 1.50" CL4 ASPH SURF 0.50A PG64-22 W/ FIBERS (PAID FOR BY FD05)
- 2 3.50" CL4 ASPH BASE 1.00D PG64-22
- 3 3.50" CL4 ASPH BASE 1.00D PG64-22
- 4.50" CL4 ASPH BASE 1.00D PG64-22


  6.00" CRUSHED STONE BASE
- (2) (6) 12.00" CRUSHED AGGREGATE NO. 2 (7) STANDARD BARRIER MEDIAN TYPE 4 OR MOUNTABLE MEDIAN TYPE 4

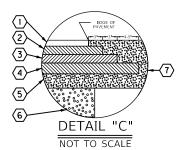

- 1.50" CL4 ASPH SURF 0.50A PG64-22 W/ FIBERS (PAID FOR BY FD05)
- (2) 3.50" CL4 ASPH BASE 1.00D PG64-22
- 3) 3.50" CL4 ASPH BASE 1.00D PG64-22
- 4.50" CL4 ASPH BASE 1.00D PG64-22
- (5) 6.00" CRUSHED STONE BASE (2) (6) 12.00" CRUSHED AGGREGATE NO. 2 (7) CRUSHED STONE BASE SHOULDER

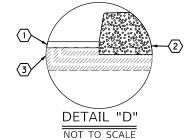

- 1.50" CL4 ASPH SURF 0.50A PG64-22 W/ FIBERS (PAID FOR BY FD05)
- STANDARD BARRIER MEDIAN TYPE 4 OR MOUNTABLE MEDIAN TYPE 4
- (3) EXISTING PAVEMENT

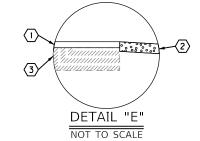

- 1.50" CL4 ASPH SURF 0.50A PG64-22 W/ FIBERS (PAID FOR BY FD05)
- (2) 2.00" CRUSHED STONE BASE
- $\overline{3}$  EXISTING PAVEMENT

### NOTES

- 1 FOR FULL DEPTH PAVEMENT LONGITUDINAL JOINTS, PERFORM ASPHALT PAVE MILLING & TEXTURING A TOTAL DEPTH OF 5.00 INCHES (AN ADDITIONAL 3.5" REQUIRED FOR MILL AND OVERLAY) AND A WIDTH OF 18.00 INCHES FROM EXISTING EDGE OF PAVEMENT FOR PAVEMENT TIE IN. SEE DETAIL "A". WILL BE PAID BY MILLING AND PAVING BID ITEMS.
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- 3 GORE AREA WIDTH VARIES
- 4 MOUNTABLE MEDIAN TYPE 3 OR STANDARD BARRIER MEDIAN TYPE 4 SEE PLANS FOR LOCATIONS
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- 7 ASPHALT SEAL REQUIRED FROM OUTSIDE EDGE OF PAVED SHOULDER TO A POINT 2 FEET DOWN THE DITCH LINE OR FILL SLOPE. TWO APPLICATIONS OF THE FOLLOWING:

  ASPHALT SEAL COAT @ 2.40 LBS./SQ. YD.

  ASPHALT SEAL AGGREGATE @ 20 LBS/SQ. YD.

DRAWING TITLE: STRATMAN ROAD AND WOLF HILLS ROAD TYPICAL SECTIONS

ITEM NO. 02-0935.00

HENDERSON

SHEET NO.

COMMONWEALTH OF KENTUCKY

DEPARTMENT OF HIGHWAYS

DRAWING TITLE: GENERAL SUMMARY SHEET

ITEM

05992

06406

06407

06410

06490

06568

06569

06574

06576

20191ED

20391NS835

21289ED

21596ND

23839EC

24589ED

24631EC

24679ED

24969ED

24889EC 26130ED

26131ED

26132ED

26132ED

	EM NO. 2-0935.00	COUNTY OF HENDERSON
SH	IEET NO.	

ITEM	DESCRIPTION	NOTE(S)	UNIT	US 41	STRATMAN ROAD	WOLF HILLS ROAD	TOTAL PROJECT
00003	CRUSHED STONE BASE	1	TON	1491	5	256	1752
00078	CRUSHED AGGREGATE SIZE NO 2	1	TON	2015		376	2391
00100	ASPHALT SEAL AGGREGATE	1	TON	7		1	8
00103	ASPHALT SEAL COAT	1	TON	1		1	2
00217	CL4 ASPH BASE 1.00D PG64-22	1	TON	1972	383		2355
00461	CULVERT PIPE-15 IN	2	LF	88			88
00462	CULVERT PIPE-18 IN	2	LF	12		24	36
00464	CULVERT PIPE-24 IN	2	LF	75			75
01310	REMOVE PIPE		LF	30		4	34
01480	CURB BOX INLET TYPE B	2	EACH	2			2
01705	REMOVE CURB & GUTTER BOX INLET		EACH	2			2
01921	STANDARD BARRIER MEDIAN TYPE 4		SQYD	143			143
01939	MOUNTABLE MEDIAN TYPE 3		SQYD	544			544
01982	DELINEATOR FOR GUARDRAIL MONO DIRECTIONAL WHITE		EACH	4		4	8
01983	DELINEATOR FOR GUARDRAIL MONO DIRECTIONAL YELLOW		EACH	16			16
02091	REMOVE PAVEMENT		SQYD			124	124
02200	ROADWAY EXCAVATION		CUYD	1482		99	1581
02351	GUARDRAIL-STEEL W BEAM-S FACE		LF	587.5		150	737.5
02367	GUARDRAIL END TREATMENT TYPE 1		EACH	1			1
02369	GUARDRAIL END TREATMENT TYPE 2A		EACH	1			1
02381	REMOVE GUARDRAIL		LF	218		163	381
02562	TEMPORARY SIGNS		SQFT	384	48	48	480
02569	DEMOBILIZATION		LS	1			1
02602	FABRIC-GEOTEXTILE CLASS 1	1	SQYD	3533		633	4166
02604	FABRIC-GEOTEXTILE CLASS 1A	1	SQYD	3848		376	4224
02625	REMOVE HEADWALL		EACH	1		1	2
02650	MAINTAIN & CONTROL TRAFFIC		LS	1			1
02671	PORTABLE CHANGEABLE MESSAGE SIGN		EACH	6			6
02701	TEMP SILT FENCE		LF	2500			2500
02703	SILT TRAP TYPE A		EACH	5			5
02704	SILT TRAP TYPE B		EACH	5			5
02705	SILT TRAP TYPE C		EACH	5			5
02706	CLEAN SILT TRAP TYPE A		EACH	5			5
02707	CLEAN SILT TRAP TYPE B		EACH	5			5
02708	CLEAN SILT TRAP TYPE C		EACH	5			5
02726	STAKING		LS	1			1
02775	ARROW PANEL		EACH	2			2
03225	TUBULAR MARKERS		EACH	45			45
04701	POLE 40 FT MTG HT	5	EACH	5			5
04725	BRACKET 15 FT	5	EACH	5			5
04740	POLE BASE	5	EACH	5			5
04750	TRANSFORMER BASE	5	EACH	5			5
04761	LIGHTING CONTROL EQUIPMENT	5	EACH	1			1
04780	FUSED CONNECTOR KIT	5	EACH	10			10
04797	CONDUIT-3 IN	5 5	LF LF	1120			1120
04820 04832	TRENCHING AND BACKFILLING WIRE-NO. 12	5	LF LF	4145 825			4145 825
04832	CABLE-NO. 8/3C DUCTED	5	LF LF	3025			3025
05950	EROSION CONTROL BLANKET	ا	SQYD	75			75
05952	TEMP MULCH		SQYD	1850			1850
05953	TEMP SEEDING AND PROTECTION		SQYD	1850			1850
05963	INITIAL FERTILIZER		TON	1030			1
05964	MAINTENANCE FERTILIZER		TON	1			1
05985	SEEDING AND PROTECTION		SQYD	1850			1850

ITEM	DESCRIPTION	NOTE(S)	UNIT	US 41	STRATMAN ROAD	WOLF HILLS ROAD	TOTAL PROJECT
00190	LEVELING & WEDGING PG64-22	6	TON	131	4	8	143
00333	CL4 ASPH SURF 0.50A PG64-22	6	TON	1307	35	75	1417
00356	ASPHALT MATERIAL FOR TACK	6	TON	6	1	1	8
02676	MOBILIZATION FOR MILL & TEXT	6	LS	1			1
02677	ASPHALT PAVE MILLING & TEXTURING	6	TON	1056	35	26	1117
02696	SHOULDER RUMBLE STRIPS	6	LF	2600			2600
06542	PAVE STRIPING-THERMO-6 IN W	6	LF	7719	235	225	8179
06543	PAVE STRIPING-THERMO-6 IN Y	6	LF	2586	294	268	3148
20071EC	JOINT ADHESIVE	6	LF	1984	154	167	2305
24785EC	FIBER REINFORCEMENT FOR HMA	6	TON	1307	35	75	1417

# NOTES

DESCRIPTION

AGRICULTURAL LIMESTONE

SBM ALUM SHEET SIGNS .080 IN

SBM ALUM SHEET SIGNS .125 IN

STEEL POST TYPE 1

CLASS A CONCRETE FOR SIGNS

PAVE MARKING-THERMO STOP BAR-24IN

PAVE MARKING-THERMO CROSS-HATCH

PAVE MARKING-THERMO CURV ARROW

PAVE MARKING-THERMO ONLY

OBJECT MARKER TY 3

ELECTRICAL JUNCTION BOX TYPE A

LONGITUDINAL EDGE KEY

GMSS TYPE D

REMOVE CONCRETE MEDIAN

LED LUMINAIRE

BARCODE SIGN INVENTORY

PAVE MARK THERMO CHEVRON

LONGITUDINAL SAW CUT

PAVE MARKING-THERMO U-TURN

SLOPED AND MITERED HEADWALL-15 IN

SLOPED AND MITERED HEADWALL-18 IN

SLOPED AND MITERED HEADWALL-24 IN

SLOPED AND MITERED HEADWALL-24 IN

- 1 CARRIED OVER FROM PAVING SUMMARY
- 2 CARRIED OVER FROM PIPE DRAINAGE SUMMARY
- 3 CARRIED OVER FROM SIGNAGE SUMMARY
- 4 CARRIED OVER FROM STRIPING SUMMARY
- 5 CARRIED OVER FROM LIGHTING PLANS
- 6 ITEMS TO BE PAID FOR BY FD05 ARE SHOWN IN TABLE BELOW

UNIT

TON

3 SQFT

3 SQFT

3 CUYD

4 EACH

SQFT

EACH

EACH

EACH LF

EACH

SQYD

EACH

EACH

SQFT

LF

4 EACH

2 EACH

2 EACH 2 EACH

2 EACH

3 LF

4

4

4

344

175

823

2

3306

13

1786

58.1

745

1786

1129

2302

153

23.2

324

153

344

175

823

2

46

6737

17

1939

6

81.3

91

1226

1939

2

TOTAL PROJECT

**GAOR NAMTARTS** 

**MOLF HILLS ROAD** 

It SN

NOTES

ITEM

PAVING AREAS

YARDS

SQUARE

DRAWING TITLE:	PAVING	SUMMARY	

QUANTITY TO BE PAID FOR BY FD05				
1.5" CL4 ASPH SURF 0.50A PG64-22		15837	907	423
FIBER REINFORCEMENT FOR HMA		15837	907	423
1. DEPTH IS AVERAGE ACROSS WEDGE	GE			
*ALL QUANTITIES CARRIED TO GENERAL SUMMARY	SAL	SUMMA	IRY	

	TOTAL PROJECT	1752	2391	8	2	2355	4166	4224
	MOLF HILLS ROAD	256	376	1	1		633	376
	<b>ДАОЯ ИАМТАЯТ</b> 2	5				383		
	I† SN	1491	2015	7	1	1972	3533	3848
	UNIT	TON	TON	TON	TON	TON	SQYD	SQYD
AR	NOTES	1	2	4	2	3		
PAVING SUMMARY	ITEM	CRUSHED STONE BASE	CRUSHED AGGREGATE SIZE NO 2	ASPHALT SEAL AGGREGATE	ASPHALT SEAL COAT	CL4 ASPH BASE 1.00D PG64-22	FABRIC-GEOTEXTILE CLASS 1	FABRIC-GEOTEXTILE CLASS 1A
	ITEM	00003	00078	00100	00103	00217	02602	02604

# \*ALL QUANTITIES CARRIED TO GENERAL SUMMARY

ESTIMATED AT 115 LBS PER SQYD PER INCH OF DEPTH ESTIMATED AT 95 LBS PER SQYD PER INCH OF DEPTH ESTIMATED AT 110 LBS PER SQYD PER INCH OF DEPTH ESTIMATED AT 20 LBS PER SQYD (2 APPLICATIONS) ESTIMATED AT 0.4 LBS PER SQYD (2 APPLICATIONS) 1.5.8.4.2

	DAOR NAMTARTS  WOLF HILLS ROPD  TOTAL PROJECT	4 8 143	35 75 1492	1.0 1 8	35 26 1117	154 167 2305	35 75 1/92
	It SU	131	1382 3	6 1	1056	1984 1	1387
	TINU	TON	TON	TON	TON	LF	TON
ARY	NOTES	7	7	6,7	7	7	7
PAVING SUMMARY	ITEM	LEVELING & WEDGING PG64-22	CL4 ASPH SURF 0.50A PG64-22	ASPHALT MATERIAL FOR TACK	ASPHALT PAVE MILLING & TEXTURING	JOINT ADHESIVE	2,4785EC FIRED DEINEODCEMENT EOD HMA
	ITEM CODE	00190	00333	00356	02677	20071EC	2/1785EC

6. ESTIMATED AT 0.84 LBS PER SQYD 7. ITEMS TO BE PAID FOR BY FDO5 ARE SHOWN IN TABLE BELOW

ITEM NO. 02-0935.00

COUNTY OF HENDERSON

COMMONWEALTH OF KENTUCKY DEPARTMENT OF HIGHWAYS

ITEM NO. 02-0935.00 SHEET NO. R6

COUNTY OF HENDERSON

ALL	QUANTITIES	CARRIED	TO	GENERAL	SUMMARY	

					Р	IPE DR	AINAGE	SUMMA	RY		
	SKEW	COVER HEIGHT	DESIGN pH LEVEL	CULVERT PIPE -15 IN	CULVERT PIPE-18 IN	CULVERT PIPE-24 IN	CURB BOX INLET TY. B	SLOPED AND MITERED HEADWALL-15IN	SLOPED AND MITERED HEADWALL-18IN	SLOPED AND MITERED HEADWALL-24IN	REMARKS
ITEM CODE				00461	00462	00464	01480	26130ED	26131ED	26132ED	
UNIT TO BID		FT		LF	LF	LF	EACH	EACH	EACH	EACH	
US 41											
101+79	00°49'41"	6.4			12		1				
105+04	03°07'28"	4.6		4		75	1				
109+44	86°27'42"	3.8		10				1			
114+30	90°00'00"	6.0		74						2	
WOLF HILLS ROAD											
301+08	14°02'32"	3.7			24				1		
TOTALS				88	36	75	2	1	1	2	

DRAWING TITLE: PIPE DRAINAGE SUMMARY SHEET

penRoads Designer v10.16.2.267	USER: ustj725830	

COMMONWEALTH OF KENTUCKY DEPARTMENT OF HIGHWAYS

FILE NAME: C:\BMS\WSP-US-PW-02\D0833597\R7 - STRIPING TABLE AND SUMMARY.DGN

DRAWING TITLE: US 41 STRIPING TABLE AND SUMMARY SHEET

64	LF	6" SOLID YELLOW	-15.53	101+04	14.71' LT	100+40	US 41
467	LF	6" SOLID YELLOW	-19.24	105+42.72	0.00'	101+08.66	US 41
389	LF	6" SOLID YELLOW	-44.25	109+52.27	19.78' LT	105+59.91	US 41
561	LF	6" SOLID YELLOW	0.00	114+17.54	0.00'	109+06.71	US 41
105	LF	6" SOLID YELLOW	-61.41	115+50.00	61.80' LT	114+45.05	US 41
TOTAL							
2586							
	·						
852	LF	6" SOLID WHITE	69.87	108+72.59	39.40' RT	100+40.00	US 41
458	LF	6" SOLID WHITE	0.00	105+49.95	15.09' RT	103+04.44	US 41
678	LF	6" SOLID WHITE	88.00	115+50.00	53.32' RT	109+35.85	US 41
29	LF	6" SOLID WHITE	28.85	108+83.32	0.00'	108+83.32	US 41
456	LF	6" SOLID WHITE	61.09	114+05.75	30.76' RT	109+56.91	US 41
487	LF	6" SOLID WHITE	-60.00	105+26.17	37.71' LT	100+40.00	US 41
320	LF	6" SOLID WHITE	-17.40	103+92.70	0.00'	100+76.91	US 41
976	LF	6" SOLID WHITE	-84.10	115+50.00	73.11' LT	105+76.86	US 41
383	LF	6" SOLID WHITE	-61.77	112+52.28	0.00'	108+83.08	US 41
60	LF	6" SOLID WHITE	-61.80	114+45.05	1.65' LT	114+42.85	US 41
116	LF	6" SOLID WHITE	40.25	301+78.45	13.11' RT	300+70.00	WOLF HILLS RD
109	LF	6" SOLID WHITE	-25.00	301+64.71	12.25' LT	300+70.00	WOLF HILLS RD
75	LF	6" SOLID WHITE	22.55	202+23.14	12.00' RT	201+39.10	STRATMAN RD
160	LF	6" SOLID WHITE	-24.31	202+28.87	12.00' LT	201+39.10	STRATMAN RD
TOTAL							
4924	Ī						
	·						
147	LF	6" DOUBLE SOLID YELLOW	0.00	202+35.18	0.00	201+39.10	STRATMAN RD
134	LF	6" DOUBLE SOLID YELLOW	0.00	301+80.83	0.00	300+70.00	WOLF HILLS RD
TOTAL							
281							
1528	LF	6" DASHED WHITE 10X30	77.00	115+50.00	26.16' RT	100+40.00	US 41
1491	LF	6" DASHED WHITE 10X30	-72.60	115+50.00	26.10' LT	100+40.00	US 41
TOTAL							
TOTAL	- 1						

STRIPING TABLE

14.30

0.00

28.85

0.00

65.00

100+72.42

105+17.43

108+83.74

114+17.30

115+50

101+04

DESCRIPTION

6" SOLID YELLOW

UNIT QUANTITY

LF 434 LF 385 LF 576 LF 239

LF 64

LF 32

ALIGNMENT BEGIN STATION BEGIN OFFSET END STATION END OFFSET

14.42' RT

14.20' RT

18.56' RT

0.00'

61.09' RT

100+40.00

101+01.41

105+02.23

109+06.71

114+05.75

100+40

US 41

US 41

US 41

US 41

US 41


US 41


	STRIPING SUMMARY													
ITEM CODE	DESCRIPTION	UNIT	QUANTITY	NOTES										
06511	PAVE STRIPING-TEMP PAINT-6 IN	LF	10210											
06542	PAVE STRIPING-THERMO-6 IN W	LF	8179	PAID FOR BY FD05										
06543	PAVE STRIPING-THERMO-6 IN Y	LF	3148	PAID FOR BY FD05										
06568	PAVE MARKING-THERMO STOP BAR-24 IN	LF	46											
06569	PAVE MARKING-THERMO CROSS-HATCH	SQFT	6737											
06574	PAVE MARKING-THERMO CURV ARROW	EACH	17											
06576	PAVE MARKING-THERMO ONLY	EACH	3											
24889EC	PAVE MARKING-THERMO U-TURN	EACH	9											

ITEM NO. 02-0935.00

SHEET NO. R7

COUNTY OF HENDERSON

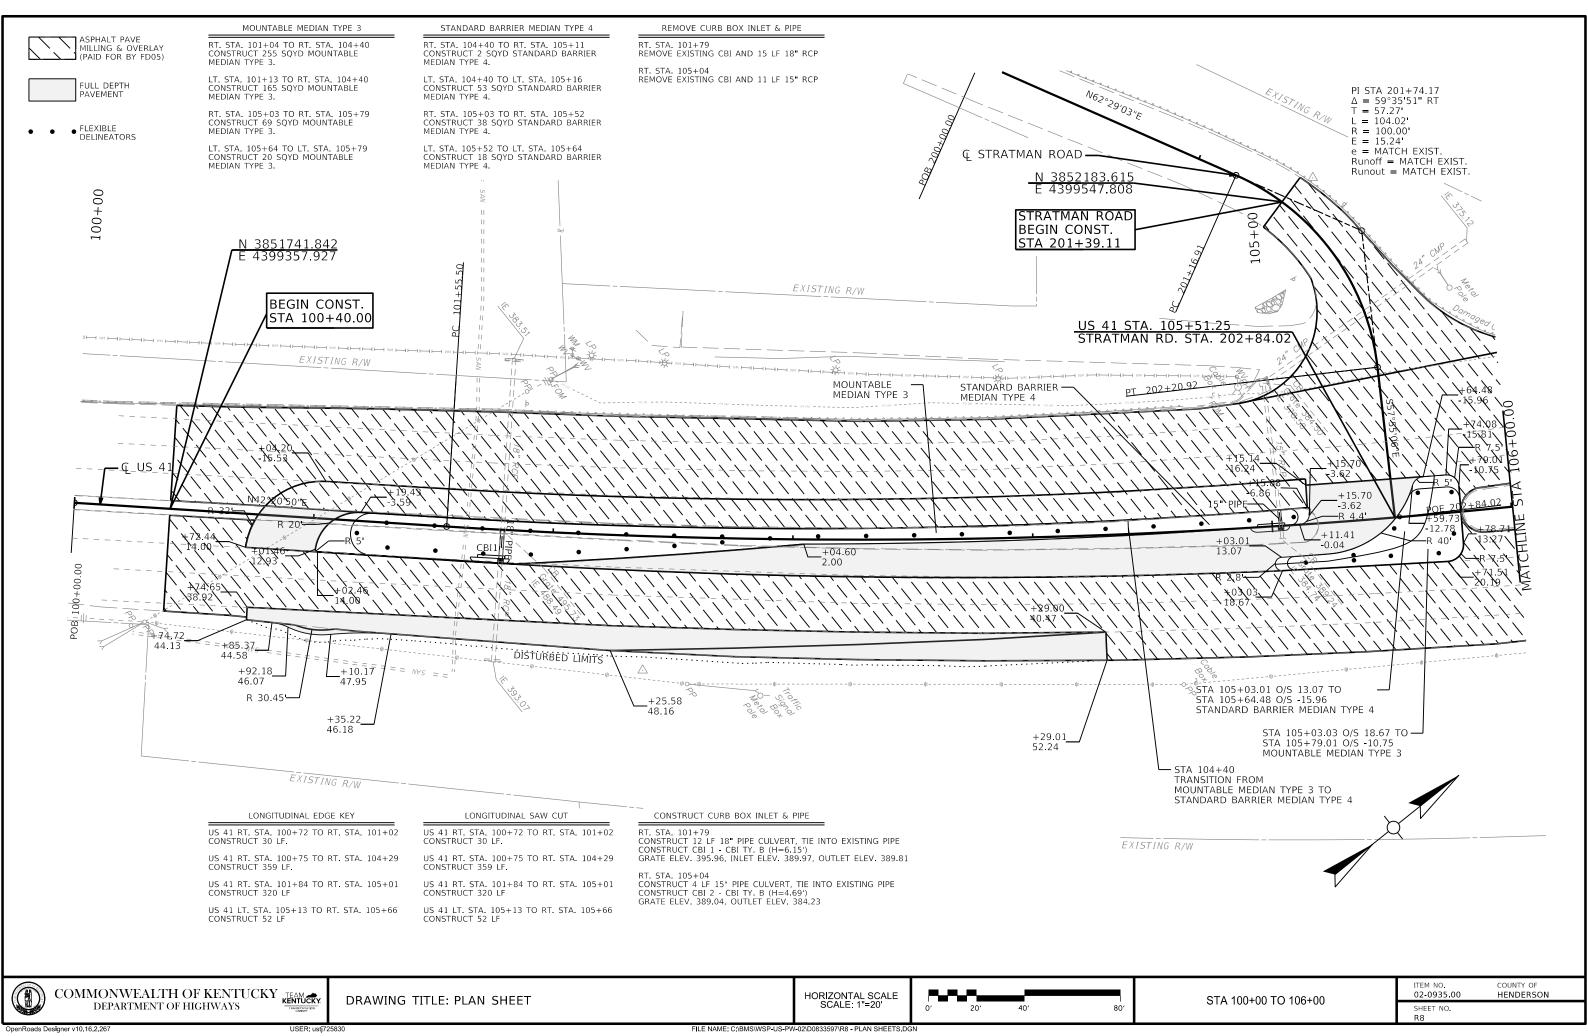

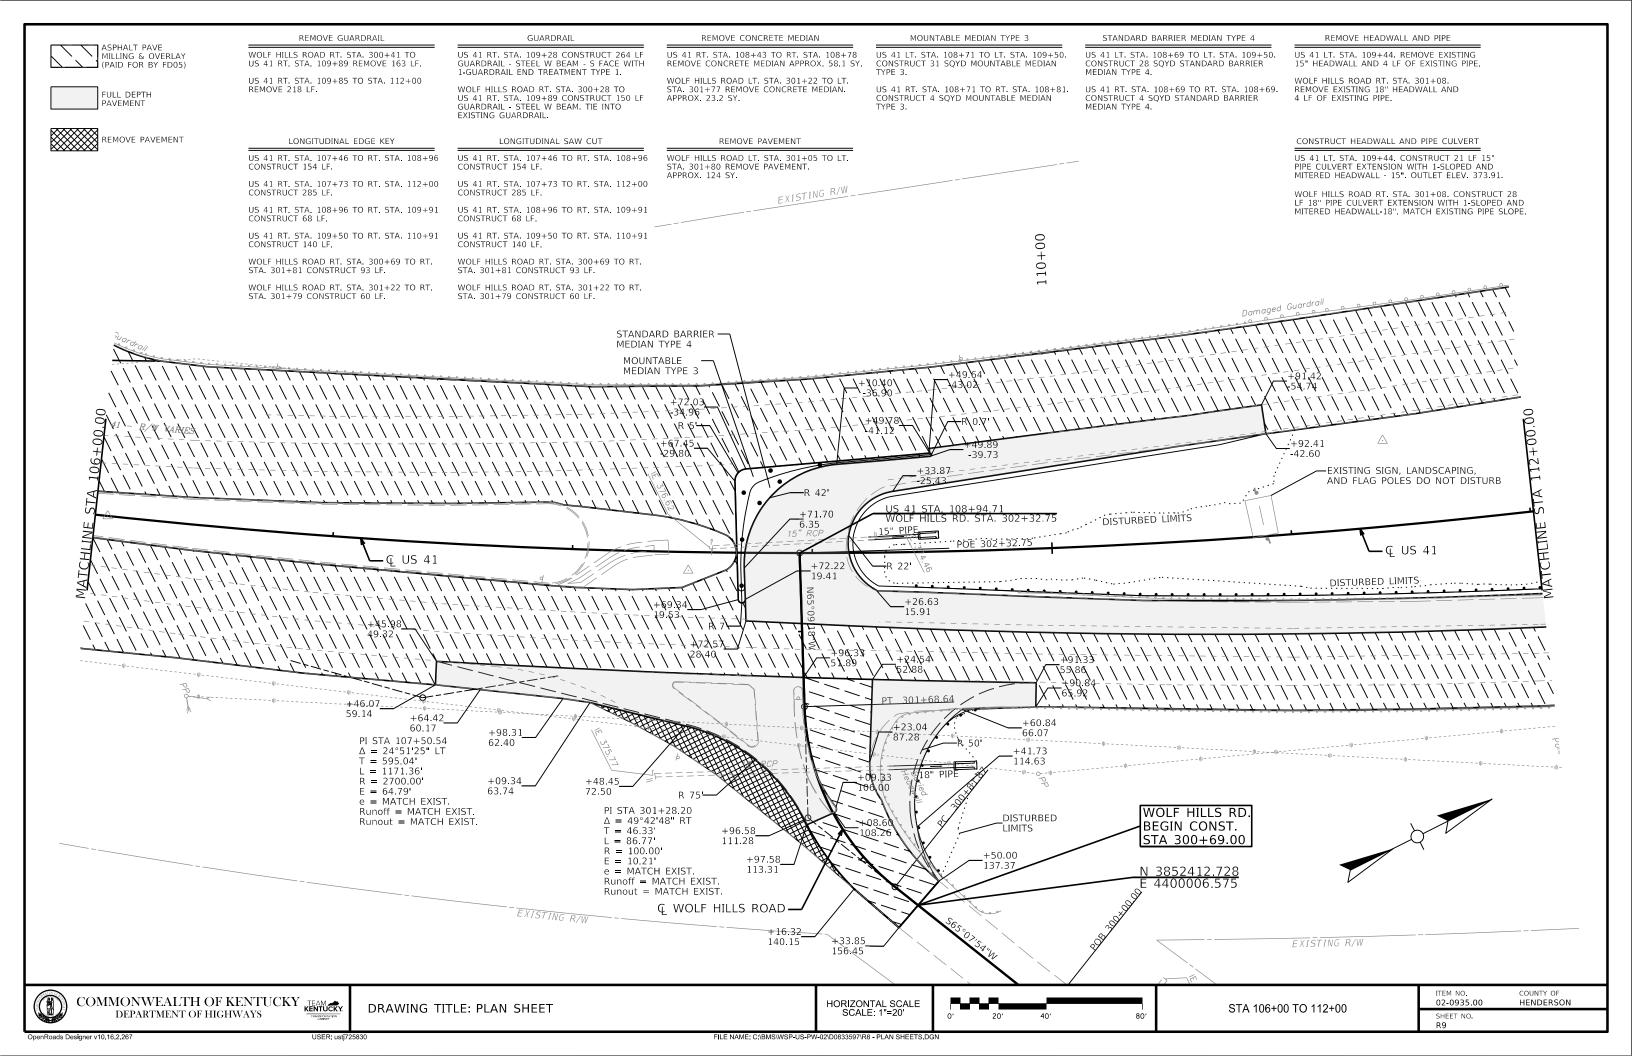

GUARDRAII REMOVE GUARDRAIL CONSTRUCT HEADWALL AND PIPE LONGITUDINAL EDGE KEY LONGITUDINAL SAW CUT ASPHALT PAVE MILLING & OVERLAY (PAID FOR BY FD05) US 41 RT. STA. 112+00 CONSTRUCT 173.5 LF GUARDRAIL - STEEL W BEAM - S FACE WITH 1-GUARDRAIL END TREATMENT

US 41 RT. STA. 112+00 TO STA. 115+50 REMOVE 358 LF. US 41 RT. STA. 114+32. CONSTRUCT 74 LF 24" PIPE CULVERT AND 2 EA SLOPED AND MITERED HEADWALL - 24IN US 41 RT. STA. 112+00 TO RT. STA. 115+03. CONSTRUCT 310 LF . US 41 RT. STA. 112+00 TO RT. STA. 115+03. CONSTRUCT 310 LF . US 41 LT. STA. 112+77 TO RT. STA. 114+45. CONSTRUCT 68 LF . US 41 LT. STA. 112+77 TO RT. STA. 114+45. CONSTRUCT 68 LF . FULL DEPTH PAVEMENT US 41 RT. STA. 114+45 CONSTRUCT 150 LF GUARDRAIL - STEEL W BEAM - S FACE WITH 1-GUARDRAIL END TREATMENT TYPE 2A. TIE INTO EXISTING GUARDRAIL. 115+00 +77.29 -49.44 +96.56 LIMITS END CONST. STA 115+50.00 R 57'-+44.85 N17°29'25"E -1.58 .... DISTURBED LIMITS DISTURBED LIMITS \_+80.56·. 51.52 +03.30 52.16 +71.45**\_** 44.84 COUNTY OF HENDERSON COMMONWEALTH OF KENTUCKY KENTUCKY HORIZONTAL SCALE SCALE: 1"=20' 02-0935.00 DRAWING TITLE: PLAN SHEET STA 112+00 TO 115+50 DEPARTMENT OF HIGHWAYS


		STATE	PLANE COORDI	NATES		
POINT	DESCRIPTION	NORTH (Y)	EAST (X)	ELEV. (Z)	STATION	OFFSET
CP1	CONTROL POINT 1	3852183.62	4399709.97	387.77	106+05.73	0.05 RT
CP2	CONTROL POINT 2	3852389.73	4399838.84	381.03	108+48.42	7.68 RT
CP3	CONTROL POINT 3	3851853.50	4399533.62	396.45	102+39.16	55.96 RT
CP4	CONTROL POINT 4	3852199.94	4399548.05	379.78	105+27.58	143.83 LT
CP6	CONTROL POINT 6	3852672.71	4399920.30	376.14	111+41.35	35.79 LT
CP7	CONTROL POINT 7	3852876.36	4400059.72	377.51	113+80.09	29.69 RT

COORDINATE CONTROL POINTS

GEOMETRIC DATA - US 41												
NAME Station Northing (Y) EASTIN												
РОВ	100+00.00	3851712.28	4399330.98									
PC	101+55.50	3851827.21	4399435.73									
PI	107+50.54	3852299.30	4399780.41									
PT	113+26.86	3852834.52	4400015.40									
POE	116+00.00	3853095.03	4400097.49									

GE	OMETRIC DA	ATA - STRATM	AN ROAD
NAME	Station	Northing (Y)	EASTING ()
РОВ	200+00.00	3852121.61	4399423.5
PC	201+16.91	3852175.62	4399527.2
PI	201+74.17	3852186.85	4399577.3
PT	202+20.92	3852171.66	4399626.5
POE	202+84.02	3852138.15	4399679.9

GE	OMETRIC DA	TA - WOLF HI	LLS ROAD
NAME	Station	Northing (Y)	EASTING (X
РОВ	300+00.00	3852441.98	4400069.69
PC	300+81.87	3852407.56	4399995.42
PI	301+28.20	3852398.28	4399953.38
PT	301+68.64	3852407.54	4399911.35
POE	302+32.75	3852434.48	4399853.16

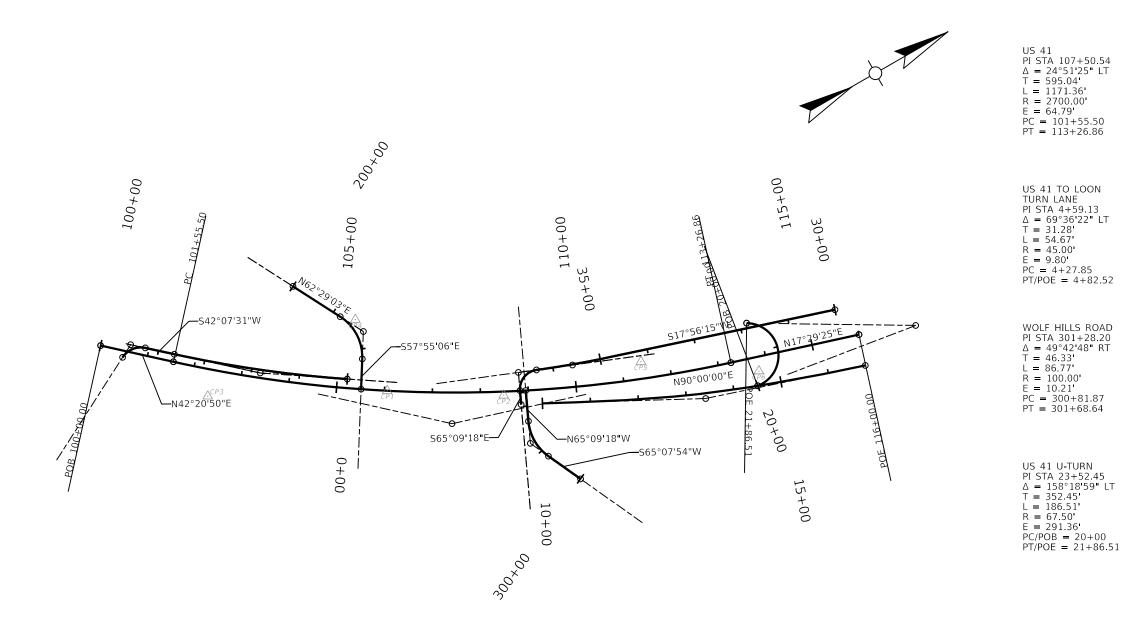

US 41 TO LOON TURN LANE

PI STA 1+82.56  $\Delta = 08^{\circ}21'11''$  RT

T = 182.56' L = 364.47' R = 2500.00' E = 6.66' PC/POB = 0+00 PT = 3+64.47

STRATMAN ROAD PI STA 201+74.17 Δ = 59°35'51" RT T = 57.27' L = 104.02'

US 41 TURN LANE TO WOLF HILLS ROAD

PI STA 36+72.87 Δ = 87°10'51" LT T = 38.08' L = 60.86' R = 40.00'

PC = 36+34.79 PT = 36+95.66

US 41 NB U-TURN TURN LANE


PI STA 13+40.95 $\Delta = 12^{\circ}40'11''$  LT


R = 3071.16' E = 18.87' PC/POB = 10+00.00 PT/POE = 16+78.99


T = 340.95'L = 679.11'


E = 15.23


R = 100.00' E = 15.24' PC = 201+16.91 PT = 202+20.92

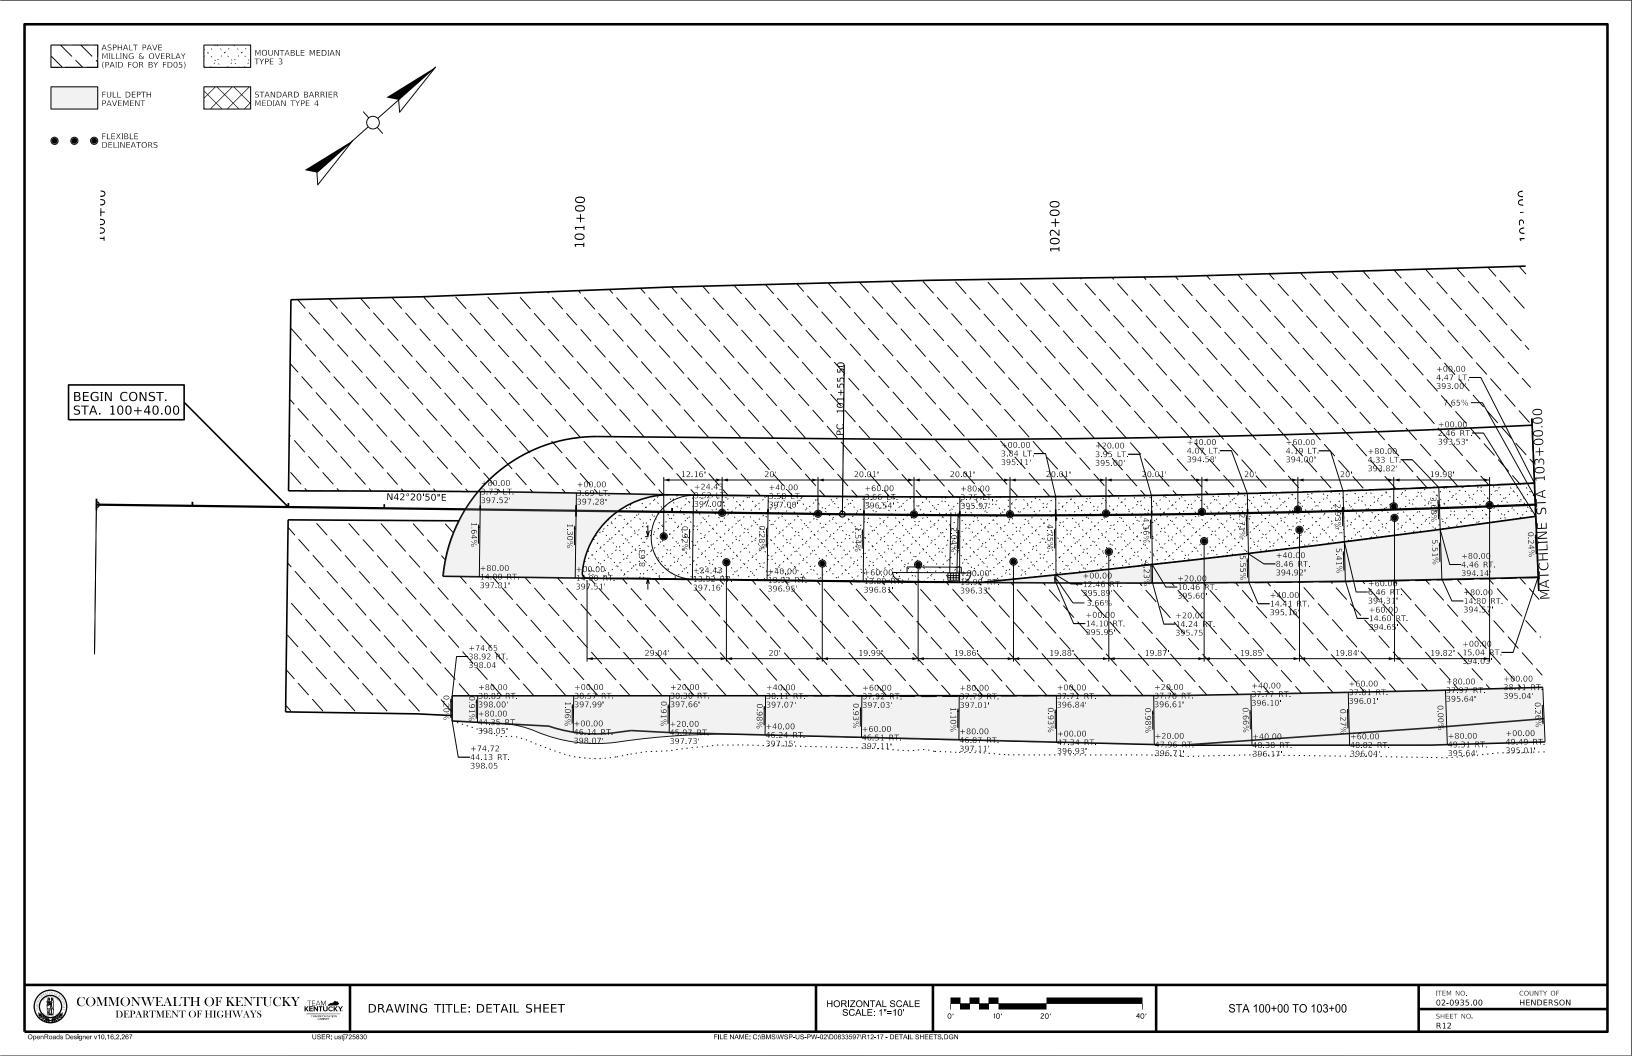


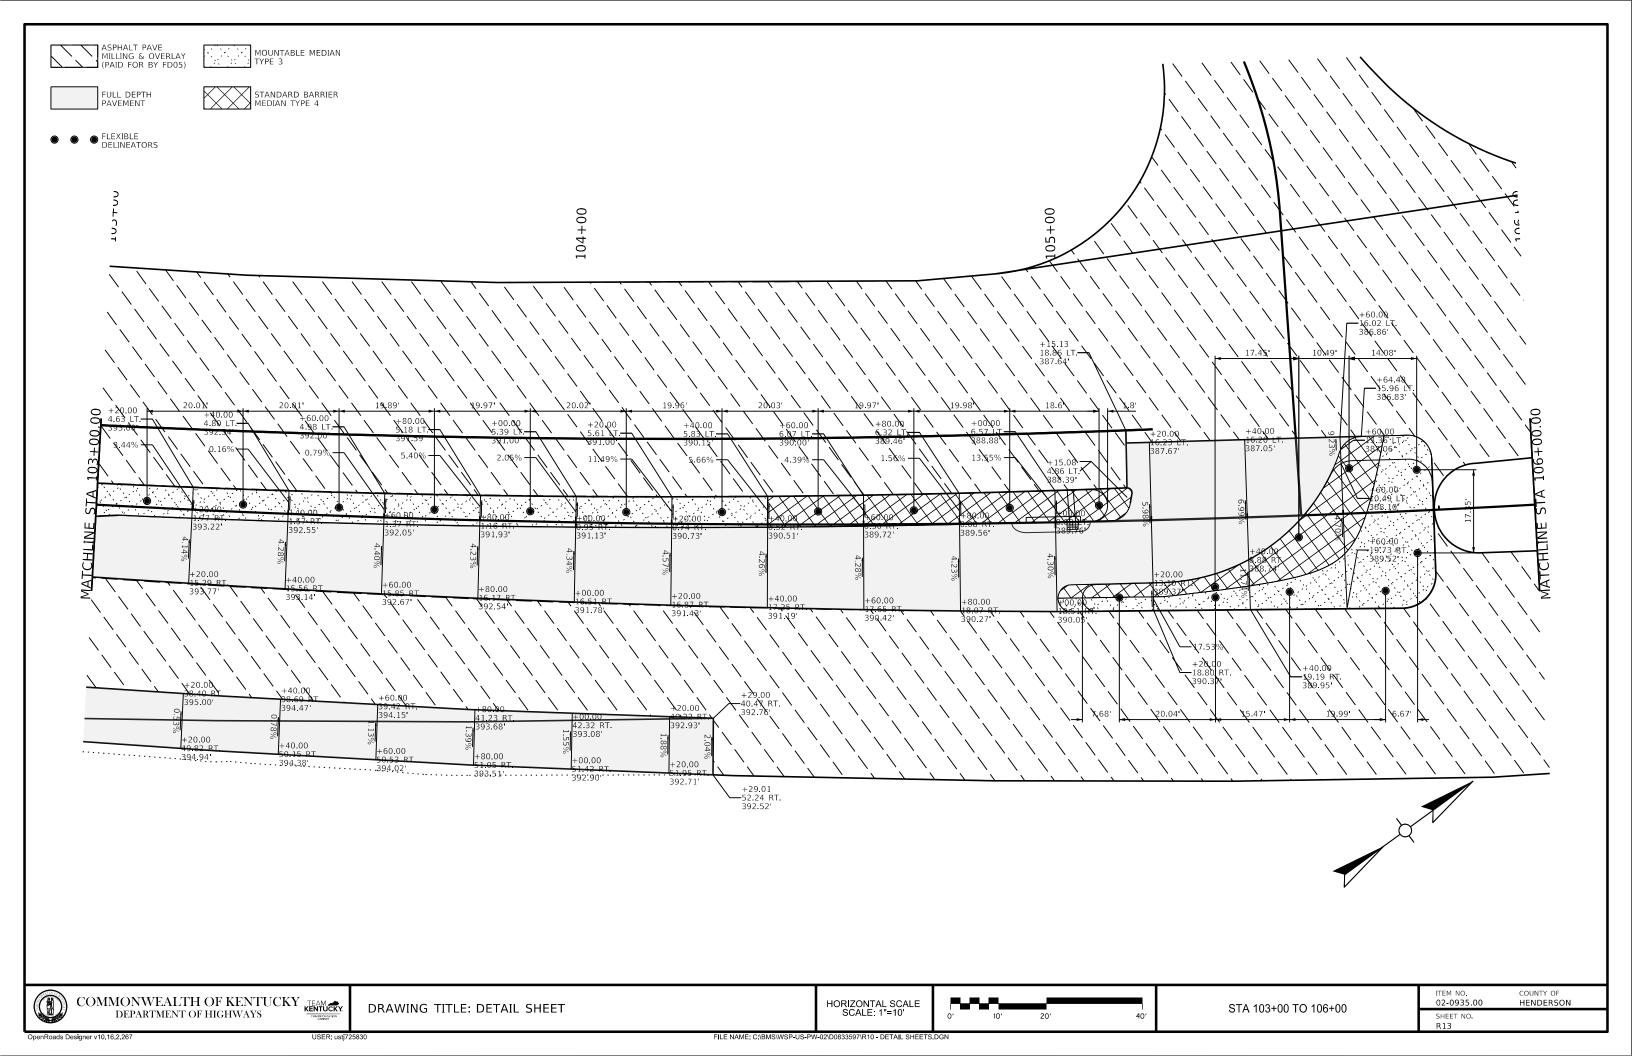


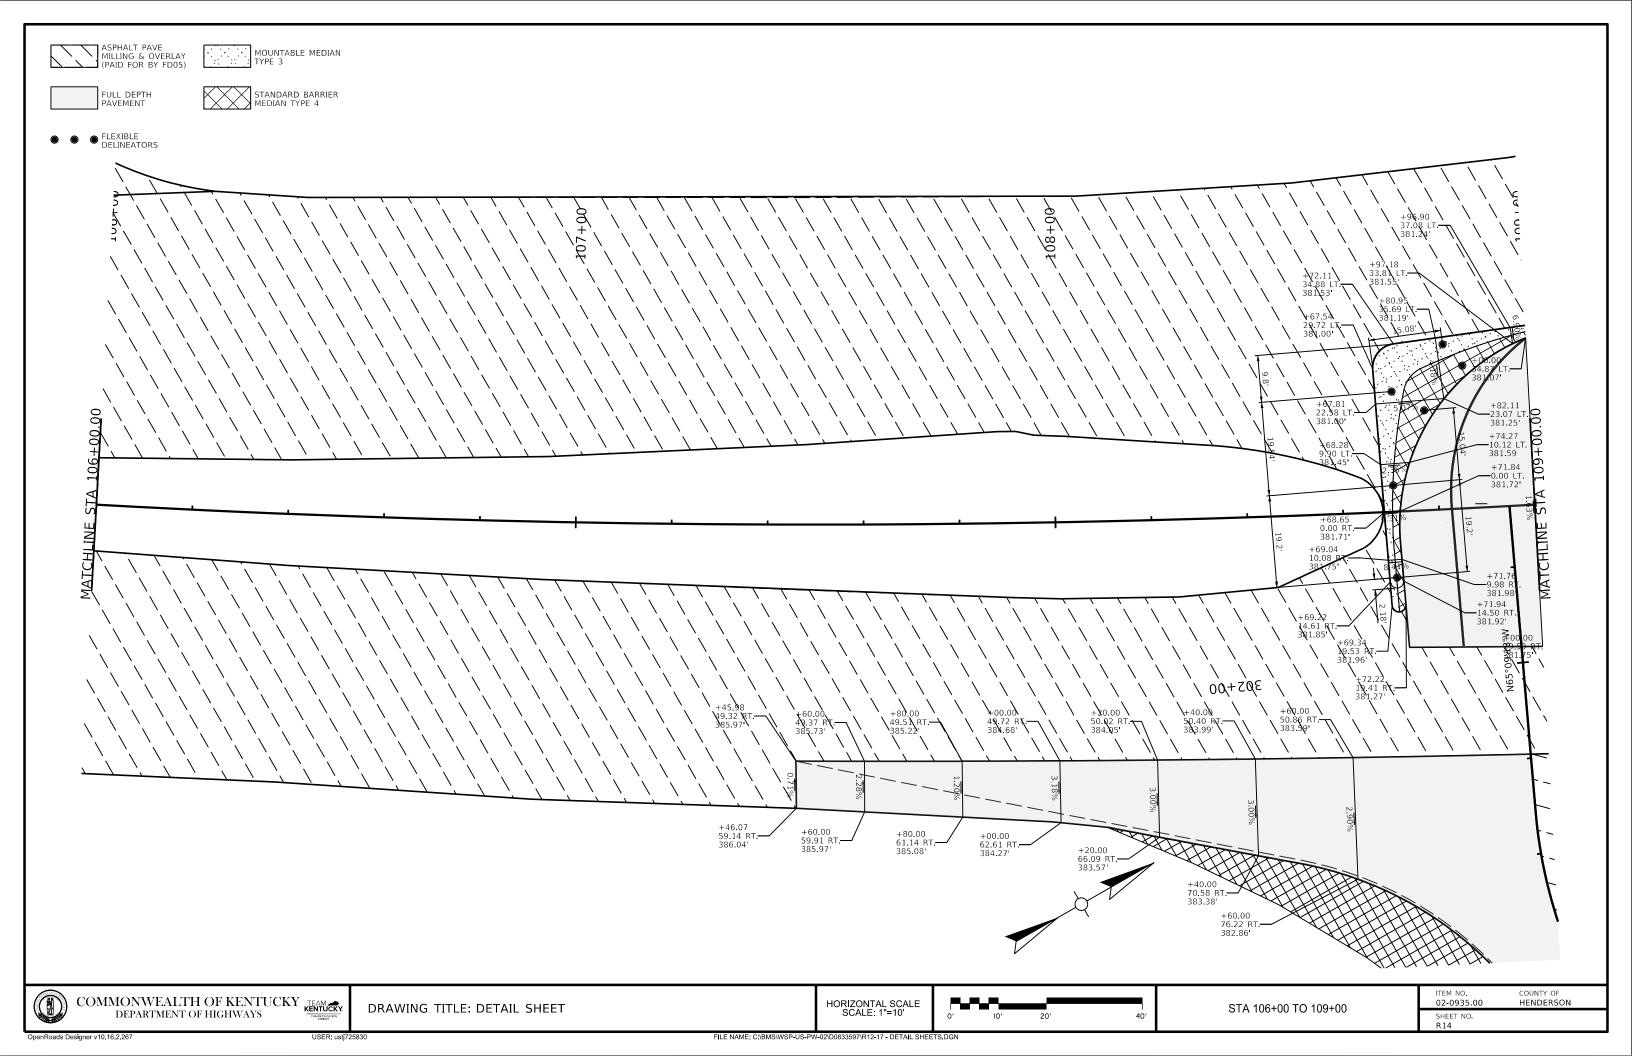


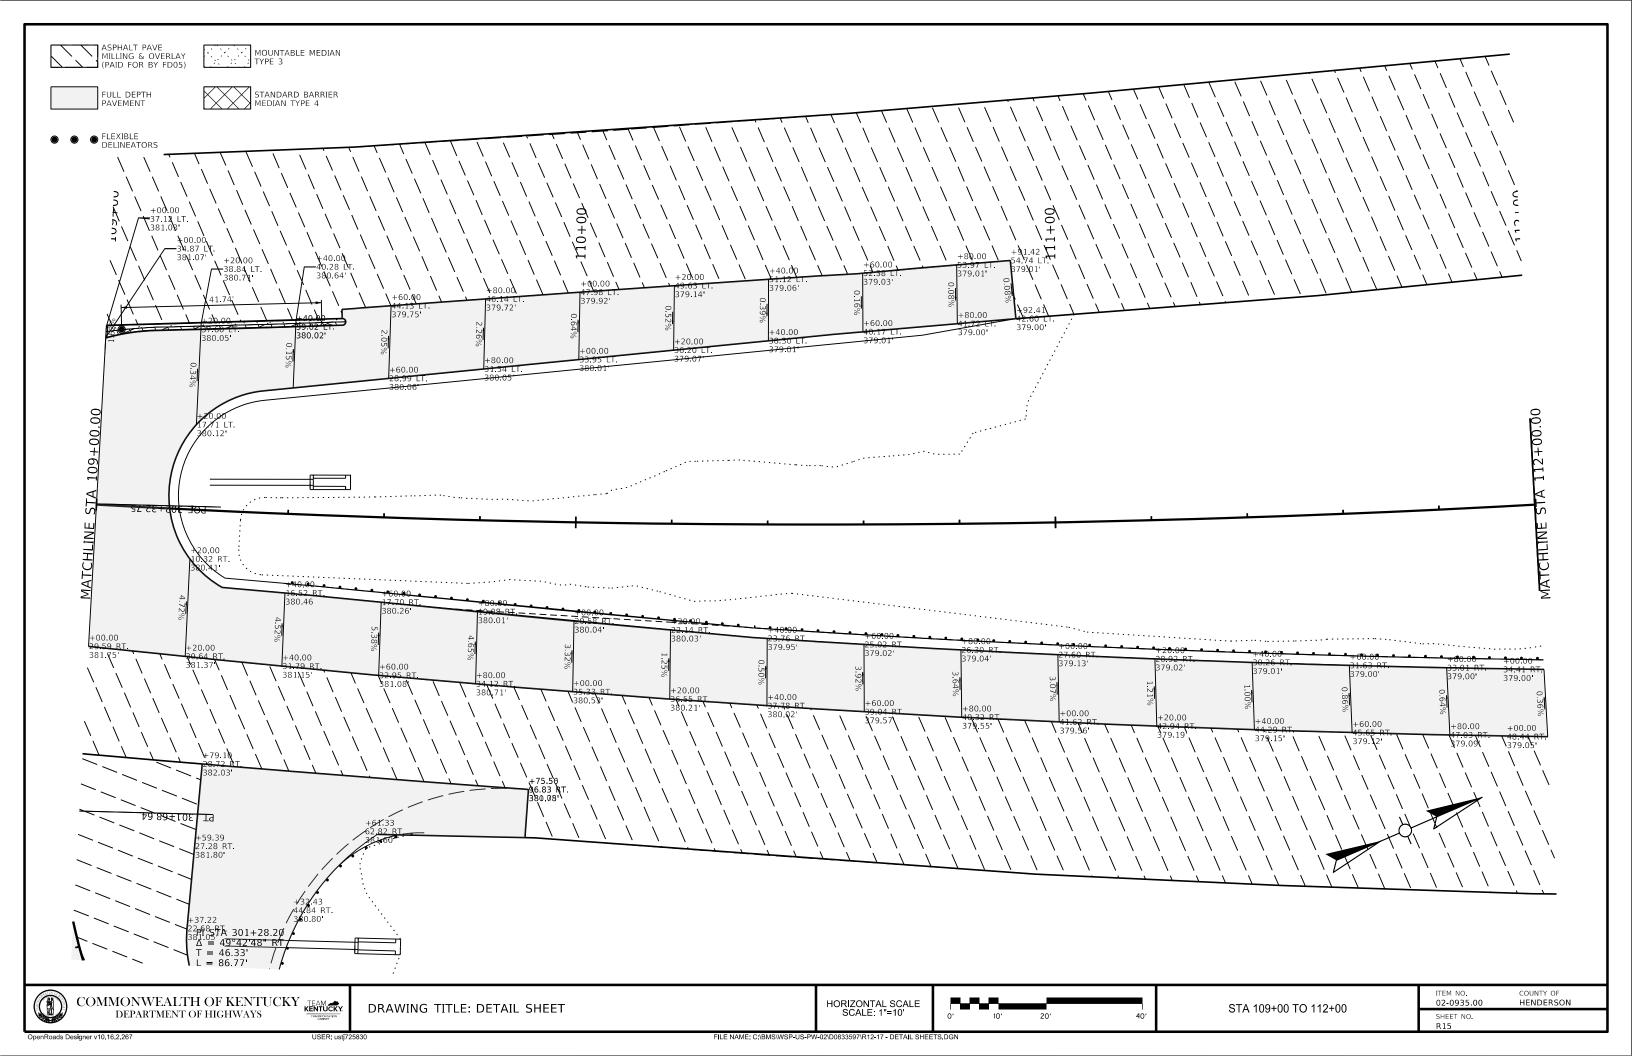


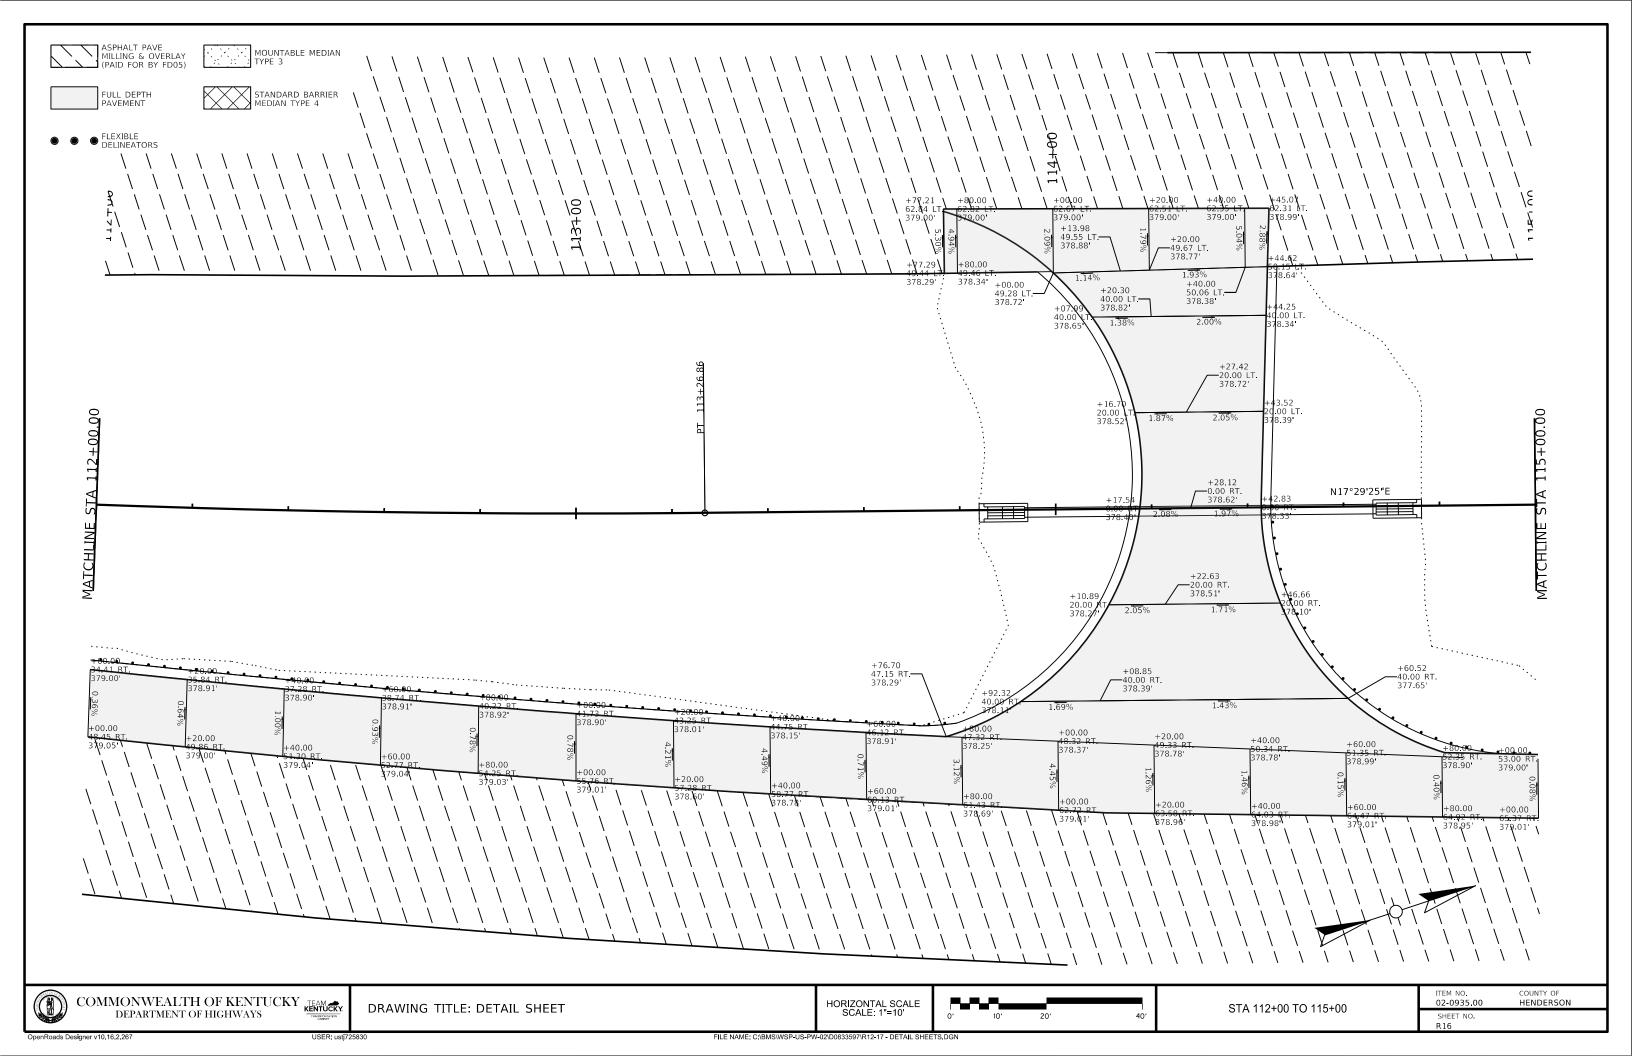


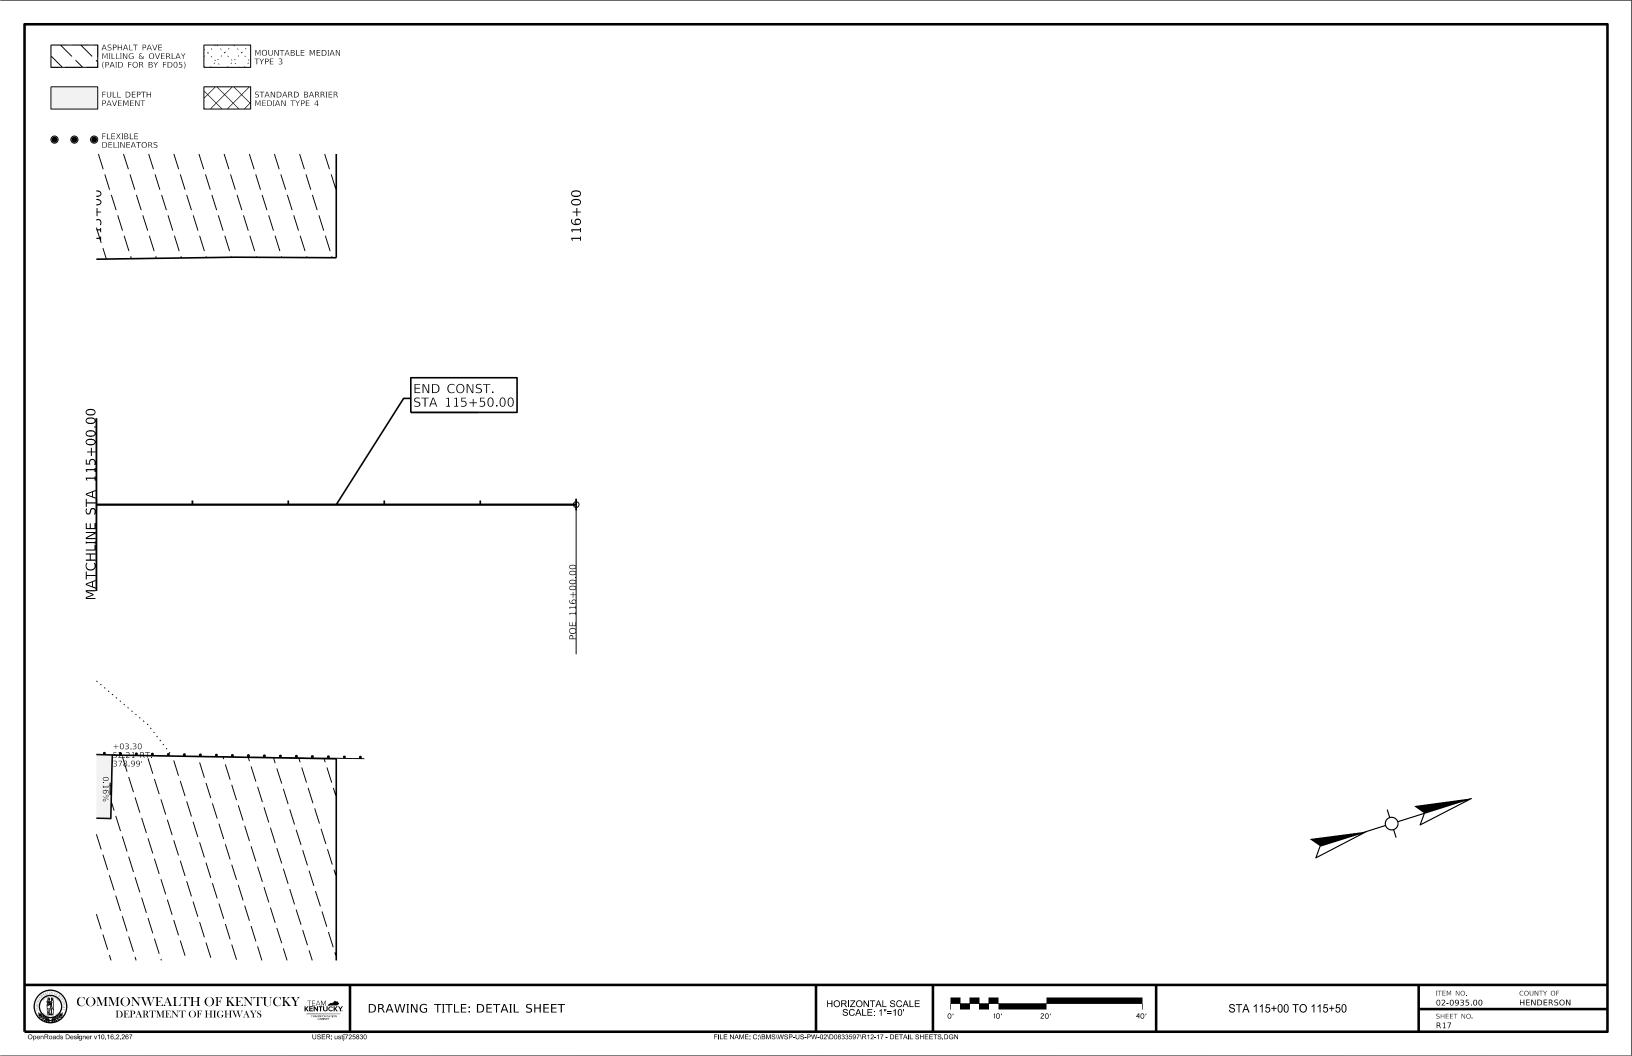


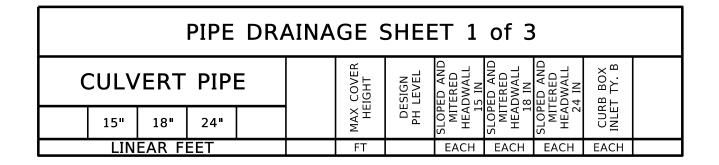


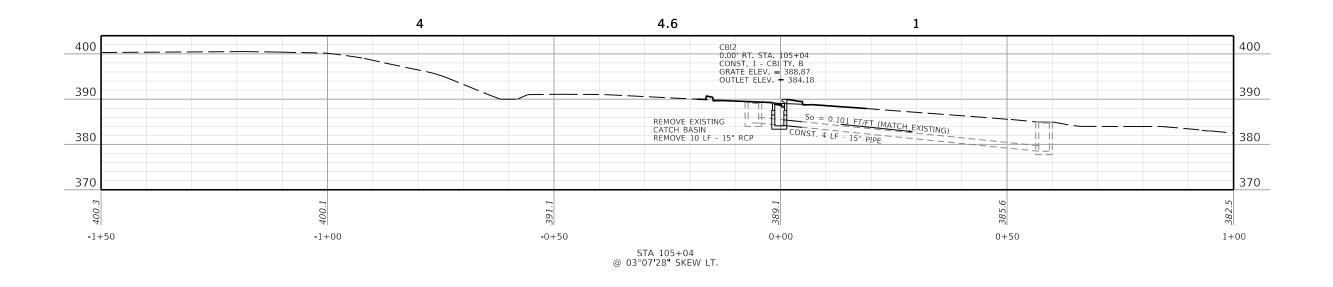

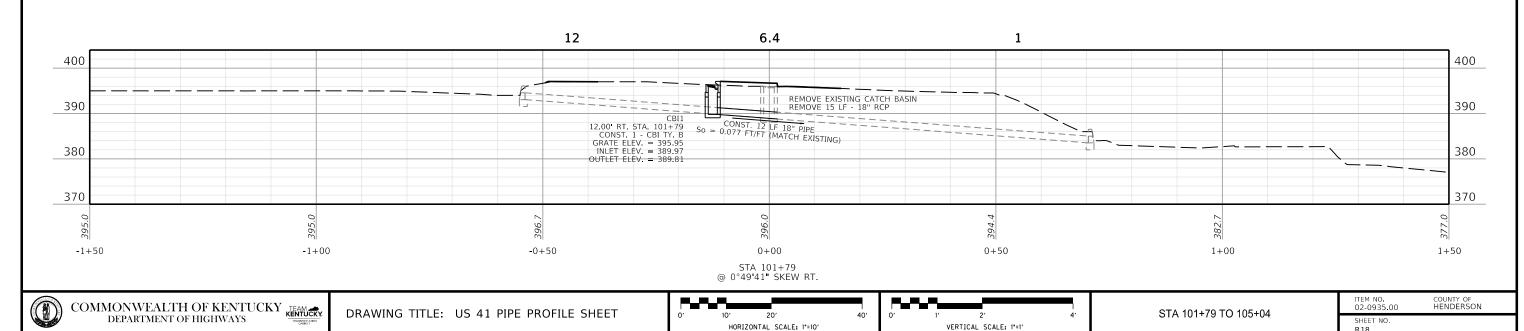

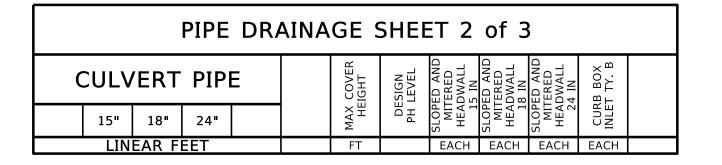

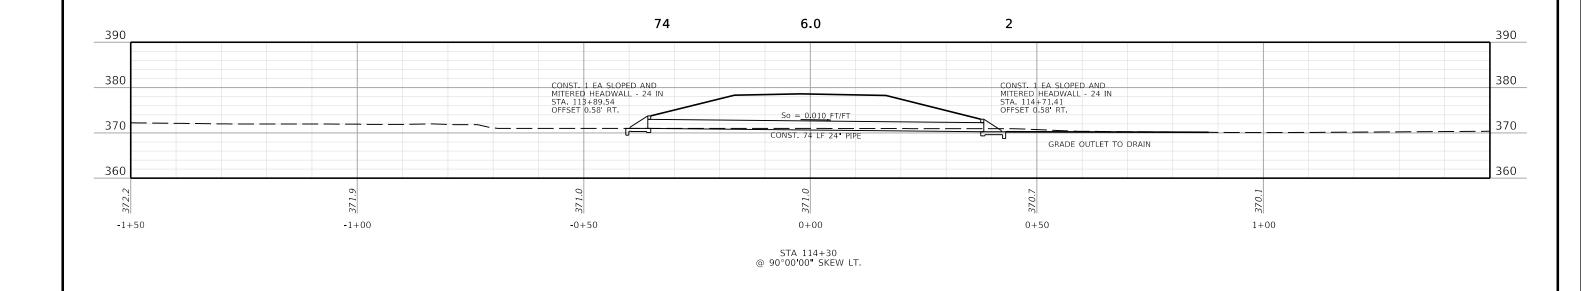


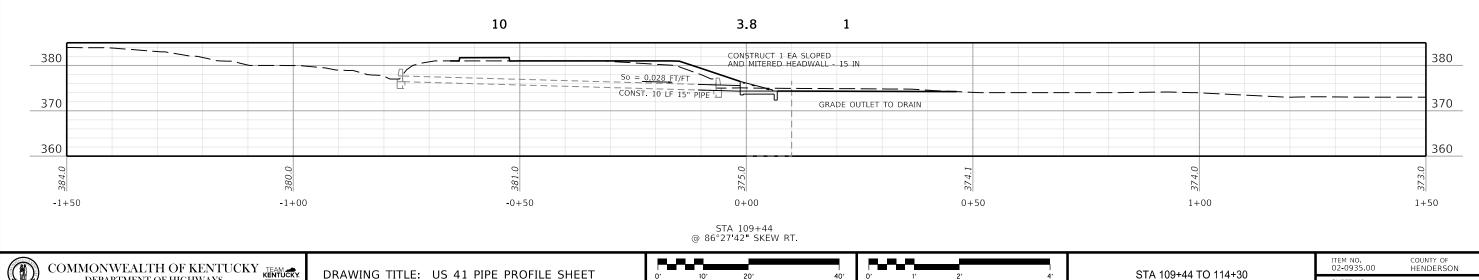

DEPARTMENT OF HIGHWAYS

HORIZONTAL SCALE: 1"=10"

PIPE DRAINAGE SHEET 3 of 3													
C	CULV	'ERT	PIPI	Е		COVER IGHT	SIGN	ED AND TERED DWALL 5 IN	ED AND TERED DWALL 8 IN	ED AND TERED DWALL 4 IN	B BOX T TY. B		
	15"	18"	24"			MAX HE	Hd 30	SLOP MIT HEA 1	SLOP MIT HEA	SLOP MIT HEA 2	CUR INLE		
	LIN	EAR F	EET			FT		EACH	EACH	EACH	EACH		

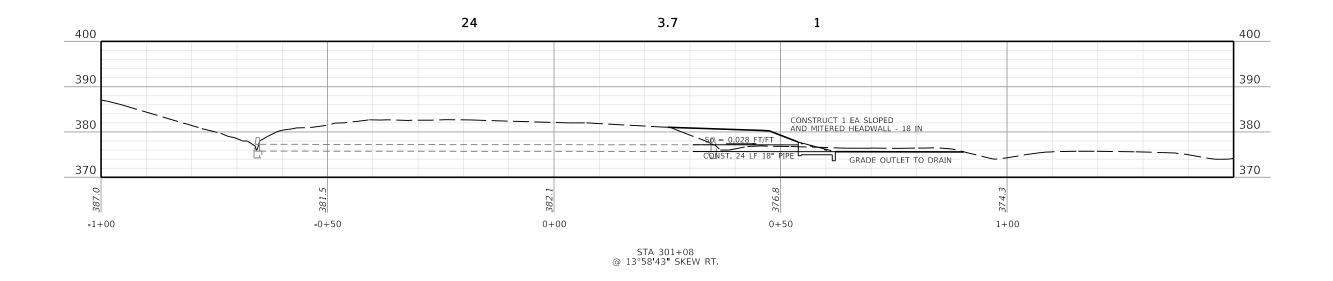

COUNTY OF HENDERSON

							Się	gn Summary	Н	lenderson	County		Route US	5-41								
		SIGN L	OCATION	l				-			SHEETING		SBM Alum	SBM Alum				- · · ·	Estimated	2-1/4''	TOTAL	<u> </u>
Assembly ID	Side of Road	Approx Offset (ft)	Approx Station	Approx. Mile Point	Facing Traffic Traveling	MUTCD Code	Sign Description	Sign Text / Remarks	Sign Dimensions (in x in)	Text/ Symbol Color	Background Color	Sheeting Type	Sheet Signs 0.080 IN (SQ FT)	Sheet Signs 0.125 IN (SQ FT)	Installation Type	Bracing Req'd	Sign	Length of 2" Post	Length of 2-1/2" Post ② (ft)	Stiffener Req'd (incdntl to post)	Estimated Sign Post Length (LF)	Barcode Sign Inv. (EACH)
S-1		0	100+13	18.300	SOUTH	R5-1a	Wrong Way		42 x 30	White	Red	ΧI		8.75	Stnd w/ Soil Plate		1	13			13	1
S-2	RT	46	100+13	18.300	SOUTH	R5-1a	Wrong Way		42 x 30	White	Red	ΧI		8.75	Stnd w/ Soil Plate		1	13			13	1
S-3		0	100+38	18.305	NORTH	R3-4	No U-Turn		36 x 36	Red & Black	White	ΧI	9.00		Stnd w/ Soil Plate		1	15			15	1
					SOUTH	R5-1	Do Not Enter		36 x 36	White	Red	ΧI	9.00		Stnd w/ Soil Plate							1
S-4	RT	46	100+38	18.305	SOUTH	R5-1	Do Not Enter		36 x 36	White	Red	ΧI	9.00		Stnd w/ Soil Plate		1	13			13	1
S-5	RT	61	101+00	18.316	SOUTH	R6-1L	One Way		48 x 18	Black	White	ΧI		6.00	Stnd w/ Soil Plate	Yes	2	12			24	1
	RT	6	101+21	18.320	SOUTH	M3-1	North		24 x 12	Black	White	ΧI	2.00		Stnd w/ Soil Plate		1	15			15	1
S-6					SOUTH	M1-4	US Route Sign (1 or 2 digit)	41	24 x 24	Black	White	XI	4.00		Stnd w/ Soil Plate							1
					SOUTH	Х	U-Turn Arrow	U-Turn Arrow	21 x 15	Black	White	ΧI	2.19		Stnd w/ Soil Plate							1
S-7	RT	6	101+86	18.333	NORTH	D1-1d	Circular Intersection Destination (1 line)	Stratman Rd	72 x 18	White	Green	ΧI		9.00	Stnd w/ Soil Plate	Yes	2	15			30	1
S-8	RT	59	101+86	18.333	NORTH	D1-1d	Circular Intersection Destination (1 line)	Stratman Rd	72 x 18	White	Green	ΧI		9.00	Stnd w/ Soil Plate	Yes	2	15			30	1
	LT	2	104+06	18.374	SOUTH	M3-1	North		24 x 12	Black	White	ΧI	2.00		Stnd w/ Soil Plate		1	15			15	1
					SOUTH	M1-4	US Route Sign (1 or 2 digit)	41	24 x 24	Black	White	ΧI	4.00		Stnd w/ Soil Plate							1
S-9					SOUTH	M6-2L	Upward Left Diagonal Arrow		21 x 15	Black	White	ΧI	2.19		Stnd w/ Soil Plate							1
					SOUTH	R3-XX	U-Turn Arrow/ Cars Only	U-Turn Arrow/ Cars Only	24 x 36	Black	White	ΧI	6.00		Stnd w/ Soil Plate							1
S-10	LT	2	104+56	18.384	SOUTH	R5-1	Do Not Enter		36 x 36	White	Red	ΧI	9.00		Stnd w/ Soil Plate		1	13			13	1
3-10					NORTH	R3-4	No U-Turn		36 x 36	Red & Black	White	ΧI	9.00		Stnd w/ Soil Plate							1
	RT	**	**	**	EAST	M2-1	Junction		21 x 15	Black	White	ΧI	2.19		Stnd w/ Soil Plate		1	14			14	1
S-11					EAST	M1-4	US Route Sign (1 or 2 digit)	41	24 x 24	Black	White	ΧI	4.00		Stnd w/ Soil Plate							1
	RT	**	**	**	EAST	M3-3	South		24 x 12	Black	White	ΧI	2.00		Stnd w/ Soil Plate	Yes	1	18			18	1
					EAST	M1-4	US Route Sign (1 or 2 digit)	41	24 x 24	Black	White	ΧI	4.00		Stnd w/ Soil Plate	Yes						1
					EAST	M5-1R	Advance Right Turn Arrow		21 x 15	Black	White	ΧI	2.19		Stnd w/ Soil Plate	Yes						1
S-12					EAST	M4-5	То		24 x 12	Black	White	ΧI	2.00		Stnd w/ Soil Plate	Yes						1
					EAST	M3-1	North		24 x 12	Black	White	ΧI	2.00		Stnd w/ Soil Plate	Yes						1
					EAST	M1-4	US Route Sign (1 or 2 digit)	41	24 x 24	Black	White	ΧI	4.00		Stnd w/ Soil Plate	Yes						1
					EAST	M5-1R	Advance Right Turn Arrow		21 x 15	Black	White	ΧI	2.19		Stnd w/ Soil Plate	Yes						1
S-13	RT	**	**	**	EAST	W3-1	Stop Ahead		36 x 36	Red & Black	Yellow	ΧI	6.25		Stnd w/ Soil Plate		1	13			13	1

\*\* SEE PLANS/DETAILS FOR LOCATION

Summary of Items (Sheet 1	of 3)	
SBM Alum Sheet Signs 0.080 INCH	98.19	SQ FT
SBM Alum Sheet Signs 0.125 INCH	41.50	SQ FT
Barcode Sign Inventory	27	EACH
Remove & Relocate Sheet Signs		EACH
Remove & Relocate Sign Assemblies		EACH

Summary of Items (Sh	eet 1 of 3)	
Steel Post - Type 1	226	LF
GMSS Type D	0	EACH
GMSS Type D (Surface Mount)	0	EACH
Class A Concrete for Signs	0	CU YD

- ① WITH PERMISSION OF THE ENGINEER, SHEETING SIGNS ON THE RAMPS AND SIDE ROADS MAY BE MOVED TO BE COMPATIBLE WITH THE EXISTING SIGNS.
- QUANTITY IS ESTIMATED. THE EXACT LENGTH SHALL BE DETERMINED BY THE CONTRACTOR AND APPROVED BY THE ENGINEER.
- ③ WHERE REQUIRED, BRACING FOR SHEETING SIGNS SHALL BE INCIDENTAL TO STEEL POST. SEE SHEETING SIGN DETAIL SHEET.

ITEM NO. 02-0935.00

							Sig	n Summary	ŀ	lenderson	County		Route US	5-41								
Assembly ID	of	Approx Offset	OCATION Approx Station	Approx. Mile	Facing Traffic	MUTCD Code	Sign Description	Sign Text / Remarks	Sign Dimensions (in x in)	Text/ Symbol	SHEETING Background Color	Sheeting Type	SBM Alum Sheet Signs 0.080 IN		Installation Type	Bracing Req'd	Sign	Estimated Length of 2" Post	Estimated Length of 2-1/2'' Post	2-1/4" Stiffener Req'd (incdntl	TOTAL Estimated Sign Post Length	Sign Inv.
	Road	(ft)		Point	Traveling					Color			(SQ FT)	(SQ FT)		3		② <sup>(ft)</sup>	② (ft)	to post)	(LF)	(EACH)
S-14	RT	**	**	**	EAST	R3-5R	Right Turn ONLY		30 x 36	Black	White	ΧI	7.50		Stnd w/ Soil Plate		1	13			13	1
P-1	RT	**	**	**	EAST		R Cut	R Cut	72 x 36	Blk/White	Green	ΧI		18.00	Type D ④	Yes	3		15		45	1
S-15	LT	70	105+05	18.393	EAST	R6-1R	One Way		36 x 12	Black	White	ΧI	3.00		Stnd w/ Soil Plate		1	14			14	1
					EAST	R1-1	Stop		36 x 36	White	Red	ΧI	9.00		Stnd w/ Soil Plate							1
	LT	3	104+96	18.391	EAST	M3-3	South		24 x 12	Black	White	ΧI	2.00		Stnd w/ Soil Plate	Yes	1	17			17	1
					EAST	M1-4	US Route Sign (1 or 2 digit)	41	24 x 24	Black	White	ΧI	4.00		Stnd w/ Soil Plate	Yes						1
					EAST	M6-1R	Right Arrow		21 x 15	Black	White	ΧI	2.19		Stnd w/ Soil Plate	Yes						1
S-16					EAST	M4-5	То		24 x 12	Black	White	ΧI	2.00		Stnd w/ Soil Plate	Yes						1
3 10					EAST	M3-1	North		24 x 12	Black	White	ΧI	2.00		Stnd w/ Soil Plate	Yes						1
					EAST	M1-4	US Route Sign (1 or 2 digit)	41	24 x 24	Black	White	ΧI	4.00		Stnd w/ Soil Plate	Yes						1
					EAST	M6-1R	Right Arrow		21 x 15	Black	White	ΧI	2.19		Stnd w/ Soil Plate	Yes						1
					EAST	R6-1R	One Way		36 x 12	Black	White	ΧI	3.00		Stnd w/ Soil Plate	Yes						1
S-17	LT	7	105+68	18.405	SOUTH	R3-2	No Left Turn		36 x 36	Red & Black	White	ΧI	9.00		Stnd w/ Soil Plate		1	13			13	1
S-18	LT	7	106+45	18.420	NORTH	R5-1	Do Not Enter		36 x 36	White	Red	ΧI	9.00		Stnd w/ Soil Plate		1	13			13	1
S-19	LT	76	106+45	18.420	NORTH	R5-1	Do Not Enter		36 x 36	White	Red	ΧI	9.00		Stnd w/ Soil Plate		1	13			13	1
S-20	LT	73	107+45	18.439	NORTH	R5-1a	Wrong Way		42 x 30	White	Red	ΧI		8.75	Stnd w/ Soil Plate		1	13			13	1
S-21	LT	11	107+45	18.439	NORTH	R5-1a	Wrong Way		42 x 30	White	Red	ΧI		8.75	Stnd w/ Soil Plate		1	13			13	1
S-22	RT	9	107+45		SOUTH	R5-1a	Wrong Way		42 x 30	White	Red	ΧI		8.75	Stnd w/ Soil Plate		1	13			13	1
S-23	RT	70	107+45	18.439	SOUTH	R5-1a	Wrong Way		42 x 30	White	Red	ΧI		8.75	Stnd w/ Soil Plate		1	13			13	1
S-24	RT	11	108+44	18.457	SOUTH	R5-1	Do Not Enter		36 x 36	White	Red	ΧI	9.00		Stnd w/ Soil Plate		1	13			13	1
S-25	RT	82	108+44	18.457	SOUTH	R5-1	Do Not Enter		36 x 36	White	Red	XI	9.00		Stnd w/ Soil Plate		1	13			13	1
S-26	RT	16	108+65	18.461	NORTH	R3-2	No Left Turn		36 x 36	Red & Black	White	XI	9.00		Stnd w/ Soil Plate		1	13			13	1
S-27	LT	19	109+30	18.474	SOUTH NORTH	R3-4 R5-1	No U-Turn		36 x 36 36 x 36	Red & Black White	White Red	XI XI	9.00 9.00		Stnd w/ Soil Plate Stnd w/ Soil Plate		1	16			16	1 1
	RT	9	109+38	18.475	WEST	M3-1	Do Not Enter North		24 x 12	Black	White	XI	2.00		•	Yes	1	17			17	1
	N1	9	109+38	18.475	WEST	M1-4	US Route Sign (1 or 2	41	24 x 12	Black	White	XI	4.00		Stnd w/ Soil Plate Stnd w/ Soil Plate	Yes	1	17			17	1
					MEGT	N4C 4D	digit)		24 45	BL I	34/1 :-		2.40		C. 1 /C :1 Pl ·	- \ \ \ \ \ \ \ \ \ \ \ \ \ \ \ \ \ \ \						
					WEST WEST	M6-1R M4-5	Right Arrow To		21 x 15 24 x 12	Black Black	White White	XI XI	2.19		Stnd w/ Soil Plate Stnd w/ Soil Plate	Yes						1 1
S-28					WEST	M3-3	South		24 x 12 24 x 12	Black	White	XI	2.00		Stnd w/ Soil Plate	Yes Yes	1					1
					WEST	M1-4	US Route Sign (1 or 2	41	24 x 12	Black	White	XI	4.00		Stnd w/ Soil Plate	Yes						1
					WEST	M6-1R	digit) Right Arrow		21 x 15	Black	White	XI	2.19		Stnd w/ Soil Plate	Yes						1
					WEST	R6-1R	One Way		36 x 12	Black	White	XI	3.00		Stnd w/ Soil Plate	Yes						1
	RT	72	109+60	18.479	WEST	R6-1R	One Way		36 x 12	Black	White	XI	3.00		Stnd w/ Soil Plate	163	1	14			14	1
S-29	111	12	105+00	10.4/3	WEST	R1-1	Stop		36 x 36	White	Red	XI	9.00		Stnd w/ Soil Plate		+ -	14			14	1
P-2	RT	**	**	**	WEST	1	R Cut	R Cut	72 x 36	Blk/White	Green	XI	2.00	18.00	Type D 4	Yes	3		15		45	1
S-30	RT	**	**	**	WEST	R3-5R	Right Turn ONLY	ii out	30 x 36	Black	White	XI	7.50	10.00	Stnd w/ Soil Plate	,	1	13	1.7		13	1
S-31	RT	**	**	**	WEST	W3-1	Stop Ahead		36 x 36	Red & Black		XI	9.00		Stnd w/ Soil Plate		1	13			13	1
	RT	**	**	**	WEST	M3-1	North		24 x 12	Black	White	ΧI	2.00		Stnd w/ Soil Plate	Yes	1	18			18	1
S-32					WEST	M1-4	US Route Sign (1 or 2 digit)	41	24 x 24	Black	White	ΧI	4.00		Stnd w/ Soil Plate	Yes						1
					WEST	M5-1R	Advance Right Turn Arrow		21 x 15	Black	White	ХI	2.19		Stnd w/ Soil Plate	Yes						1

\*\* SEE PLANS/DETAILS FOR LOCATION

Summary of Items (Sheet 2 of 3)							
SBM Alum Sheet Signs 0.080 INCH	170.94	SQ FT					
SBM Alum Sheet Signs 0.125 INCH	71.00	SQ FT					
Barcode Sign Inventory	40	EACH					
Remove & Relocate Sheet Signs		EACH					
Remove & Relocate Sign Assemblies		EACH					

Summary of Items (Sheet 2 of 3)							
Steel Post - Type 1	355	LF					
GMSS Type D	6	EACH					
GMSS Type D (Surface Mount)	0	EACH					
Class A Concrete for Signs	1.5	CU YD					

- ① WITH PERMISSION OF THE ENGINEER, SHEETING SIGNS ON THE RAMPS AND SIDE ROADS MAY BE MOVED TO BE COMPATIBLE WITH THE EXISTING SIGNS.

  ③ WHERE REQUIRED, BRACING FOR SHEETING SIGNS SHALL BE INCIDENTAL TO STEEL POST. SEE SHEETING SIGN DETAIL SHEET.
- QUANTITY IS ESTIMATED. THE EXACT LENGTH SHALL BE DETERMINED BY THE CONTRACTOR AND APPROVED BY THE ENGINEER.
- QUANTITY SHALL INCLUDE ALL MATERIAL NECESSARY TO FORM A COMPLETE BREAK-AWAY ASSEMBLY. TYPE 1 POSTS AND CONCRETE SHALL BE PAID SEPARATELY. SEE SIGN DETAIL SHEET.

DRAWING TITLE: SIGNING SUMMARY SHEET 2

ITEM NO. 02-0935.00 COUNTY OF HENDERSON SHEET NO. R22

						ı	J18	n Summary	•	lenderson			Route US								1	
Assembly ID	Side of Road	Approx Offset (ft)	Approx Station	Approx. Mile Point	Facing Traffic Traveling	MUTCD Code	Sign Description	Sign Text / Remarks	Sign Dimensions (in x in)	Text/ Symbol Color	Background Color	Sheeting Type	Sheet	SBM Alum Sheet Signs 0.125 IN (SQ FT)	Installation Type	Bracing Req'd	# of Sign Posts	Estimated Length of 2" Post (ft)	Estimated Length of 2-1/2'' Post ② (ft)	2-1/4" Stiffener Req'd (incdntl to post)	TOTAL Estimated Sign Post Length (LF)	Sign
					WEST	M4-5	То		24 X 12	Black	White	ΧI	2.00		Stnd w/ Soil Plate	Yes						1
					WEST	M3-3	South		24 X 12	Black	White	ΧI	2.00		Stnd w/ Soil Plate	Yes			<u> </u>			1
S-32 (CONT.)					WEST	M1-4	US Route Sign (1 or 2 digit)	41	24 X 24	Black	White	ΧI	4.00		Stnd w/ Soil Plate	Yes						1
					WEST	M5-1R	Advance Right Turn Arrow		21 X 15	Black	White	ΧI	2.19		Stnd w/ Soil Plate	Yes						1
	RT	**	**	**	WEST	M2-1	Junction		21 X 15	Black	White	ΧI	2.19		Stnd w/ Soil Plate		1	14	<u> </u>		14	1
S-33					WEST	M1-4	US Route Sign (1 or 2 digit)	41	24 X 24	Black	White	ΧI	4.00		Stnd w/ Soil Plate							1
	RT	18	110+80	18.502	NORTH	M3-3	South		24 X 12	Black	White	ΧI	2.00		Stnd w/ Soil Plate		1	15			15	1
S-34					NORTH	M1-4	US Route Sign (1 or 2 digit)	41	24 X 24	Black	White	ΧI	4.00		Stnd w/ Soil Plate							1
					NORTH	M6-2L	Upward Left Diagonal Arrow		21 X 15	Black	White	XI	2.19		Stnd w/ Soil Plate							1
S-35	LT	42	112+89	18.542	SOUTH	D1-1d	Circular Intersection Destination (1 line)	Wolf Hills Rd	75 X 18	White	Green	ΧI		9.38	Stnd w/ Soil Plate	Yes	2	12			24	1
S-36	LT	105	112+89	18.542	SOUTH	D1-1d	Circular Intersection Destination (1 line)	Wolf Hills Rd	75 X 18	White	Green	XI		9.38	Stnd w/ Soil Plate	Yes	2	12			24	1
	RT	37	113+59	18.555	NORTH	M3-3	South		24 X 12	Black	White	ΧI	2.00		Stnd w/ Soil Plate		1	15			15	1
S-37					NORTH	M1-4	US Route Sign (1 or 2 digit)	41	24 X 24	Black	White	ΧI	4.00		Stnd w/ Soil Plate							1
					NORTH	Х	U-Turn Arrow	U-Turn Arrow	21 X 15	Black	White	ΧI	2.19		Stnd w/ Soil Plate							1
S-38	LT	101	114+36	18.569	NORTH	R6-1L	One Way		48 X 18	Black	White	ΧI		6.00	Stnd w/ Soil Plate	Yes	2	12	<u> </u>		24	1
S-39	LT	101	114+62	18.574	NORTH	R5-1	Do Not Enter		36 X 36	White	Red	ΧI	9.00		Stnd w/ Soil Plate		1	13	<u> </u>		13	1
S-40	LT	47	114+70	18.576	SOUTH	R3-4	No U-Turn		36 X 36	Red & Black	White	ΧI	9.00		Stnd w/ Soil Plate		1	13	<u> </u>		13	1
S-41	LT	76	106+62	18.423	NORTH	R5-1 D1-1	Do Not Enter  Destination ( 1 line)	Stratman Rd	36 X 36 74 X 18	White White	Red Green	XI	9.00	9.25	Stnd w/ Soil Plate Stnd w/ Soil Plate	Yes	2	12			24	1
S-42	RT	80	108+25	18.454	NORTH	D1-1	Destination ( 1 line)	Wolf Hills Rd	77 X 18	White	Green	ΧI		9.63	Stnd w/ Soil Plate	Yes	2	12			24	1
S-43	RT	3	102+21	18.339	SOUTH	R3-XX	U-Turn Arrow/ Cars Only	U-Turn Arrow/ Cars Only	24 X 36	Black	White	ΧI	6.00		Stnd w/ Soil Plate		1	13			13	1
S-44	RT	11	108+65	18.461	SOUTH	R3-1	No Right Turn		36 x 36	Red & Black	White	ΧI	9.00		Stnd w/ Soil Plate		1	13			13	1
S-45	LT	47	115+70	18.595	NORTH	R5-1a	Wrong Way		42 x 30	White	Red	ΧI		8.75	Stnd w/ Soil Plate		1	13			13	1
S-46	LT	100	115+70	18.595	NORTH	R5-1a	Wrong Way		42 x 30	White	Red	ΧI		8.75	Stnd w/ Soil Plate		1	13			13	1

\*\* SEE PLANS/DETAILS FOR LOCATION

Summary of Items (Sheet 3 of 3)						
SBM Alum Sheet Signs 0.080 INCH	74.75	SQ FT				
SBM Alum Sheet Signs 0.125 INCH	61.13	SQ FT				
Barcode Sign Inventory	24	EACH				
Remove & Relocate Sheet Signs		EACH				
Remove & Relocate Sign Assemblies		EACH				

Summary of Items (Sheet 3 of 3)						
Steel Post - Type 1	242	LF				
GMSS Type D	0	EACH				
GMSS Type D (Surface Mount)	0	EACH				
Class A Concrete for Signs	0	CU YD				

Total Summary of Items						
SBM Alum Sheet Signs 0.080 INCH	343.88	SQ FT				
SBM Alum Sheet Signs 0.125 INCH	173.63	SQ FT				
Barcode Sign Inventory	91	EACH				
Remove & Relocate Sheet Signs		EACH				
Remove & Relocate Sign Assemblies		EACH				

Total Summary of Items						
Steel Post - Type 1	823	LF				
GMSS Type D	6	EACH				
GMSS Type D (Surface Mount)	0	EACH				
Class A Concrete for Signs	1.5	CU YD				

NOTES:

- (1) WITH PERMISSION OF THE ENGINEER, SHEETING SIGNS ON THE RAMPS AND SIDE ROADS MAY BE MOVED TO BE COMPATIBLE WITH THE EXISTING SIGNS.
- ② QUANTITY IS ESTIMATED. THE EXACT LENGTH SHALL BE DETERMINED BY THE CONTRACTOR AND APPROVED BY THE ENGINEER.
- WHERE REQUIRED, BRACING FOR SHEETING SIGNS SHALL BE INCIDENTAL TO STEEL POST. SEE SHEETING SIGN DETAIL SHEET.

COMMONWEALTH OF KENTUCKY CHINCAY DEPARTMENT OF HIGHWAYS

INCIDENTAL TO STEEL POST. SEE SHEETIF

COUNTY OF HENDERSON

ITEM NO. 02-0935.00

SHEET NO. R23

# SIGNING SPECIFICATION NOTES

# THE FOLLOWING PUBLICATIONS ARE APPLICABLE TO THE WORK DESCRIBED HEREIN:

KENTUCKY DEPARTMENT OF HIGHWAYS STANDARD SPECIFICATIONS FOR ROAD AND BRIDGE CONSTRUCTION (CURRENT EDITION)

STANDARD HIGHWAY SIGNS AND MARKINGS (CURRENT EDITION) - FEDERAL HIGHWAY ADMINISTRATION MANUAL ON UNIFORM TRAFFIC CONTROL DEVICES (CURRENT EDITION) - FEDERAL HIGHWAY ADMINISTRATION

### SCOPE OF WORK

TO FURNISH, FABRICATE AND ERECT IN PLACE ALL MATERIALS NECESSARY TO FORM COMPLETED SIGNS AS INDICATED AT LOCATIONS DESCRIBED ELSEWHERE IN THESE PLANS. NEW SIGNS ARE TO BE INSTALLED AT EXISTING LOCATIONS UNLESS OTHERWISE NOTED ON THE PLANS.

### SIGN SUBSTRATES

SIGN SUBSTRATES SHALL CONFORM TO SECTION 833 OF KENTUCKY'S STANDARD SPECIFICATIONS FOR ROAD AND BRIDGE CONSTRUCTION (CURRENT EDITION) AND THESE PLANS. PANEL SIGNS SHALL BE LABELED AS P-#. SHEETING SIGNS SHALL BE LABELED AS S-#.

### SIGN MATERIALS

### SIGN SHEETING:

SIGN SHEETING SHALL CONFORM TO SECTION 830 OF KENTUCKY'S STANDARD SPECIFICATIONS FOR ROAD AND BRIDGE CONSTRUCTION (CURRENT EDITION) AND THESE PLANS. ONLY SHEETING ON THE DEPARTMENT'S LIST OF APPROVED MATERIALS SHALL BE USED.

ALL RETROREFLECTIVE MATERIALS SHALL BE FABRICATED AND ASSEMBLED IN ACCORDANCE WITH MANUFACTURER'S SPECIFICATIONS AND/OR RECOMMENDATIONS.

PERMANENT SIGNS AND SIGN COMPONENTS SHALL BE FABRICATED USING TYPE XI SHEETING:

THE FOLLOWING SIGNS SHALL BE FABRICATED USING TYPE XI FLUORESCENT YELLOW SHEETING:

- HORIZONTAL ALIGNMENT SIGNS AND PLAQUES
- ALL ADVISORY SPEED PLAQUES
- WARNING MESSAGES ON PANEL SIGNS

THE FOLLOWING SIGNS SHALL BE FABRICATED USING TYPE XI FLUORESCENT YELLOW-GREEN SHEETING:
- ALL SCHOOL AND SCHOOL BUS WARNING SIGNS.

- BICYCLE WARNING SIGNS AND 'SHARE THE ROAD' PLAQUES OR DIAGONAL DOWNWARD POINTING ARROW PLAQUES THAT SUPPLEMENT BICYCLE WARNING SIGNS.
- PEDESTRIAN WARNING SIGNS AND DIAGONAL DOWNWARD POINTING ARROW PLAQUES THAT SUPPLEMENT PEDESTRIAN WARNING SIGNS
- IN-STREET PEDESTRIAN CROSSING (R1-6) SIGNS AND OVERHEAD PEDESTRIAN CROSSING (R1-9) SIGNS
- SUPPLEMENTAL PLAQUES TO ANY OF THE PREVIOUSLY LISTED FLUORESCENT YELLOW-GREEN SIGNS LISTED ABOVE

ALL OTHER PERMANENT SIGNS (INCLUDING THE BACKGROUNDS OF PANEL SIGNS) SHALL BE FABRICATED LISING TYPE VI SHEETING

### LETTERS, SYMBOLS, AND BORDERS:

LETTERS, SYMBOLS AND BORDERS ARE TO BE APPLIED TO THE SIGN FACE USING THE "DIRECT APPLIED" METHOD.

PANEL OVERLAY SECTIONS SHALL BE AFFIXED WITH A "POP" RIVET WITH A MINIMUM DIAMETER OF 3/16 INCH, AND THE LENGTH SHALL BE AS NECESSARY TO PROPERLY APPLY COPY IN A WORKMANLIKE MANNER.

### HARDWARE:

ALL HARDWARE FOR THE ASSEMBLY OF PANEL SIGNS AND THE ATTACHMENT OF THESE SIGNS TO THEIR SUPPORTS SHALL BE AS RECOMMENDED BY THE PANEL MANUFACTURER. PLACEMENT OF POST CLIP SHALL BE AS SHOWN ON THE SIGNING MISCELLANEOUS DETAIL SHEET.

ALL HARDWARE FOR THE ERECTION OF SHEETING SIGNS SHALL BE CADMIUM PLATED STEEL IN ACCORDANCE WITH ASTM B-776 AND ASTM A-307.

### FONTS

CLEARVIEW 5-W SHALL BE USED FOR PLACE NAMES AND DESTINATIONS COMPRISED OF A MIX OF UPPER AND LOWER CASE LETTERS. STANDARD ALPHABETS SHALL BE USED FOR ALL OTHER TEXT ON PANEL GUIDE SIGNS.

### GROUND-MOUNTED SIGN SUPPORTS

### GENERAL:

ALL SIGNS SHALL BE POSITIONED AS SHOWN ON THE POSITIONING DETAIL SHEET. ALL BEAMS AND POSTS SHALL BE OF SUFFICIENT LENGTHS TO EXTEND FROM THE TOP OF THE SIGN TO THE REQUIRED BASE EMBEDMENT. EXISTING I-BEAMS ON WHICH SHEETING SIGNS ARE ATTACHED SHALL BE REMOVED AND REPLACED WITH TYPE I OR TYPE II POSTS, UNLESS THEY ARE LOCATED BEHIND GUARDRAIL.

### BEAMS

ALL BEAMS SHALL BE EITHER TYPE "A" (STANDARD BEAM INSTALLATION) OR TYPE "C" (BREAKAWAY SIGN POST SUPPORT SYSTEM INSTALLATION). TYPE "A" BEAMS ARE SHOWN ON THE PANEL SIGN DETAIL SHEET, AND THE TYPE "C" BEAMS ARE SHOWN ON THE BREAKAWAY SIGN SUPPORT SYSTEM FOR "C" BEAM SHEET. ONLY BREAKAWY (TYPE "C") BEAM SUPPORT SYSTEMS ON THE DEPARTMENT'S LIST OF APPROVED MATERIALS SHALL BE USED. THE TYPE AND SIZE OF BEAM TO BE USED SHALL BE INDICATED FOR EACH PANEL SIGN ON THE SIGN DETAIL SHEETS. BEAM LENGTHS INCLUDED IN THESE PLANS ARE FOR INFORMATIONAL PURPOSES ONLY. THE CONTRACTOR SHALL TAKE FIELD MEASUREMENTS AT EACH SIGN LOCATION AND CROSS SECTIONS SHALL BE DEVELOPED TO VERIFY BEAM LENGTHS, WITH ANY DISCREPANCIES BROUGHT TO THE ATTENTION OF THE ENGINEER FOR PESSOLUTION.

### STEEL POSTS:

TYPE I STEEL POSTS SHALL BE EITHER STANDARD INSTALLATION IN SOIL, WITH SOIL STABILIZER, OR TYPE "D" (BREAKAWAY SIGN POST SUPPORT SYSTEM INSTALLATION).

ONLY BREAKAWAY TYPE "D" POST SYSTEMS ON THE DEPARTMENT'S LIST OF APPROVED MATERIALS SHALL BE USED. BRACING, IF REQUIRED, SHALL BE INCIDENTAL TO TYPE I POST.

TYPE II POST SHALL BE STANDARD INSTALLATION IN SOIL WITH A SOIL STABILIZER. INSTALLATION PROCEDURES AND BRACING REQUIREMENTS ARE DETAILED ON THE SHEETING SIGN DETAIL SHEET.

ALL STEEL POSTS SHALL MEET THE REQUIREMENTS OF SECTION 832 OF THE STANDARD SPECIFICATIONS FOR ROAD AND BRIDGE CONSTRUCTION.

### MILEPOST MARKERS AND ENHANCED REFERENCE MARKERS

MILEPOST MARKERS AND ENHANCED REFERENCE LOCATION SIGNS SHALL CONFORM TO THE GENERAL REQUIREMENTS SET FORTH IN THE MANUAL ON UNIFORM TRAFFIC CONTROL DEVICES (CURRENT EDITION). ADDITIONAL REQUIREMENTS ARE GIVEN ON THE SIGNING POSITIONING DETAIL SHEET AND ENHANCED REFERENCE LOCATION SIGNS DETAIL SHEET.

FOR THE LOUISVILLE AREA, FINAL LOCATION OF ENHANCED REFERENCE LOCATION SIGNS SHALL BE VERIFIED BY TRIMARC. NOTIFY A REPRESENTATIVE OF TRIMARC AT LEAST TWO WEEKS IN ADVANCE OF BEGINNING WORK ON THIS ITEM:

901 WEST MAIN STREET LOUISVILLE, KY 40202 502-587-6624 270-307-7456

### MEDIAN CROSSOVER SIGNS

THE CONTRACTOR SHALL INSTALL 48" X 48", "NO U TURN" SIGNS (R3-4) AT EACH MEDIAN CROSSOVER. THIS IS TO BE DONE WHETHER ALL NEEDED INSTALLATIONS ARE MENTIONED IN THE FOLLOWING SHEETS OR NOT. AT CROSSOVERS ON MEDIANS SIXTY FEET (60') WIDE OR LESS, THE SIGNS SHALL BE MOUNTED PERPENDICULAR TO THE ROADWAY ON THE SAME POSTS IN THE CENTER OF THE MEDIAN, ONE FACING TRAFFIC IN EACH DIRECTION. AT CROSSOVERS ON MEDIANS OVER SIXTY FEET (60') WIDE, THE SIGNS SHALL BE MOUNTED PERPENDICULAR TO THE ROADWAY ON SEPARATE POSTS AT THE MEDIAN SHOULDER ON THE FAR SIDE OF THE CROSSOVER, ONE FACING TRAFFIC IN EACH DIRECTION. FOR ADDITIONAL GUIDANCE, SEE SEPIA DRAWING FOR FLEXIBLE DELINEATOR POST ARRANGEMENT FOR INTERCHANGE RAMPS AND CROSSOVERS.

### CONCRETE BASES

ALL CONCRETE BASES SHALL BE OF CLASS "A" CONCRETE FOR SIGNS AND SHALL BE AS SHOWN ELSEWHERE IN THESE PLANS. EXCAVATION NECESSARY TO CONSTRUCT BASES AND FOOTINGS IS INCIDENTAL TO THE COST OF CLASS "A" CONCRETE FOR SIGNS.

### CONCRETE BASES (CONTINUED)

WHERE THE REMOVAL OF OVERHEAD STRUCTURE CONCRETE BASE IS CALLED FOR, THE BASE IS TO BE REMOVED TO A MINIMUM OF ONE FOOT (1') BELOW THE GROUND LINE, BACKFILLED TO EXISTING GROUND LINE, AND THE DISTURBED AREAS RESEEDED.

WHERE THE REMOVAL OF BEAM SIGN SUPPORTS IS CALLED FOR, THE BEAM AND ANY CONCRETE PROJECTING ABOVE THE GROUND LINE ARE TO BE CUT OFF A MINIMUM OF ONE FOOT (1') BELOW EXISTING GROUND LINE OR THE ENTIRE BEAM AND CONCRETE BASE ARE TO BE REMOVED COMPLETELY AND BACKFILLED TO EXISTING GROUND LINE.

### SAMPLES, TESTING, ETC.

BEFORE BEGINNING INSTALLATION, THE CONTRACTOR SHALL FURNISH TO THE PROJECT ENGINEER DRAWINGS, DESCRIPTIONS, MANUFACTURER'S CUTS ETC. FOR WRITTEN APPROVAL OF ALL MATERIALS TO BE USED. MILL TEST REPORTS FOR BEAMS, STEEL PANELS, AND EACH DIFFERENT GAUGE OF ALUMINUM OR STEEL SHEETING USED MUST BE SUBMITTED TO THE DIVISION OF CONSTRUCTION AND APPROVED PRIOR TO ERECTION.

### MISCELLANEOUS

THE COST FOR REMOVING EXISTING PANEL SIGNS SHALL BE INCIDENTAL TO THE COST OF THE PROJECT

ON SHEETING SIGNS WHERE THERE ARE MORE THAN ONE SIGN ASSEMBLY MOUNTED BESIDE EACH OTHER, THE POSTS SHALL BE SPACED TO PROVIDE APPROXIMATELY SIX INCHES (6") OF SPACING BETWEEN SIGNS.

CLEARING AND GRUBBING, AND TREE TRIMMING, WHEN REQUIRED FOR CONSTRUCTION OR VISIBILITY OF SIGNS, SHALL BE INCIDENTAL TO THE CONTRACT.

SIGN COVERING IS NOT RECOMMENDED. HOWEVER, IF IT IS ABSOLUTELY NECESSARY TO COVER THE SIGN FACE TEMPORARILY FOLLOWING ERECTION, USE CAUTION SINCE SOME COVERINGS MAY CAUSE PERMANENT DAMAGE TO THE SIGN FACE FOLLOWING EXPOSURE TO MOISTURE, SUNLIGHT, ETC. POROUS CLOTH OR GEOTEXTILE FABRIC COVERS WHICH ARE FOLDED OVER THE SIGN EDGES AND SECURED AT THE BACK OF THE SIGN HAVE BEEN USED SUCCESSFULLY FOR LIMITED PERIODS. DO NOT USE TAPE, PAPER, PLASTIC, OR SHEET METAL COVERS. ANY SIGNS THAT ARE DAMAGED AS A RESULT OF COVERING SHALL BE REPLACED BY THE CONTRACTOR AT NO ADDITIONAL COST TO THE DEPARTMENT.

TYPE I AND II STEEL POSTS IN SOIL SHALL BE DRIVEN 32" TO 34" BELOW THE GROUND LINE AS SHOWN. HOWEVER, IF SOLID ROCK IS ENCOUNTERED, THE CONTRACTOR SHALL DRILL HOLES OF THE REQUIRED DEPTH INTO THE ROCK AND BACKFILL WITH CONCRETE. THE COST SHALL BE INCIDENTAL TO STEEL POST, AND SOIL STABILIZERS WILL NOT BE REQUIRED.

ANY AREA DISTURBED SHALL BE SIDE GRADED TO THE EXISTING SLOPES AND RESEEDED AS DIRECTED BY THE ENGINEER. AT NO ADDITIONAL COST TO THE DEPARTMENT.

REMOVE AND DO NOT REPLACE THE WHITE ON BLUE GENERAL SERVICES SIGNS AT THE EXIT RAMP TERMINALS, "EMERGENCY STOPPING ONLY" SIGNS, AND THE ROUTE MARKER THAT IS LOCATED INSIDE THE INTERCHANGE PAST THE EXIT GORE AREA.

INSTALLATION OF ADVISORY EXIT AND RAMP SPEED SIGNS (W13-2 AND W13-3) SHALL CONFORM TO THE MANUAL ON UNIFORM TRAFFIC CONTROL DEVICES (MUTCD).

ALL EXISTING SHEETING SIGNS WITHIN THE LIMITS OF THIS PROJECT ARE TO BE REMOVED AND REPLACED WITH NEW SIGNS AND POSTS. SIGNS AND POSTS SHALL CONFORM TO CURRENT STANDARDS/SPECIFICATIONS. THE COST FOR REMOVING EXISTING SIGNS GIGNS AND POSTS, RELOCATING EXISTING SIGNS AND POSTS TO CONFORM TO THE SIGNING PLANS AND SPECIFICATIONS, AND ALL HARDWARE REQUIRED, SHALL BE INCIDENTAL TO THE PROJECT. IN ADDITION TO REPLACING ALL EXISTING SIGNS, ALL SIGNS SHOWN ON THE SIGNING PLANS MUST BE INSTALLED. FOR SIGN SIZES AND SPECIFICATIONS, SEE THE CURRENT PROJECT SIGNING PLAN DETAIL SHEETS.

THE COST FOR SIGN BRACKETS AND ANY OTHER HARDWARE REQUIRED TO ATTACH NEW SIGNS ON EXISTING TRUSSES AND CANTILEVERS SHALL BE INCLUDED IN THE UNIT PRICE OF SIGN BASE MATERIAL FOR PANEL SIGNS.

DUPLICATE SIGNS SHALL NOT BE DISPLAYED DURING THE CONSTRUCTION OF THIS PROJECT.

SHEETING SIGNS (D1-1, D1-2, D1-3) EQUAL TO OR LESS THAN 72" X 42" REQUIRE TWO TYPE I OR TYPE II POSTS.

THE HORIZONTAL CLEARANCE "X" ON ALL THE SHEETING SIGNS SHOULD BE A MINIMUM OF 6' FROM THE EDGE OF THE SHOULDER TO THE EDGE OF THE SIGN OR A MINIMUM OF 12' FROM THE EDGE OF THE SIGN TO THE EDGE OF THE TRAVELLED WAY AS SHOWN IN THE SIGNING POSITIONING DETAIL SHEET.

IF ANY SIGN IS LOCATED NEAR A LUMINAIRE OR ANOTHER POLE, IT SHALL BE INSTALLED IN ADVANCE OF THE POLE SO THAT THE MOTORISTS VIEW OF THE SIGN WILL NOT BE OBSTRUCTED.

SIGNS THAT DO NOT COMPLY WITH THE MUTCD SHALL BE REMOVED BY THE CONTRACTOR AS APPROVED AND DIRECTED BY THE ENGINEER.

6-24-2020


COMMONWEALTH OF KENTUCKY DEPARTMENT OF HIGHWAYS

DRAWING TITLE: SIGNING SPECIFICATION SHEET

ITEM NO. 02-0935.00 COUNTY OF HENDERSON

SHEET NO. R24

### MILEPOST MARKERS

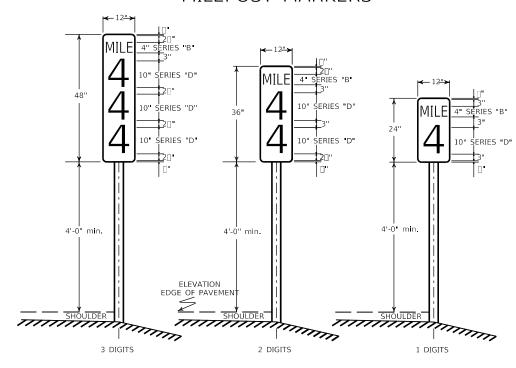

### TYPICAL SIGN PANEL DIMENSIONS AND MILEPOST LOCATIONS

MILE POST	STATION NUMBER *
NUMBER	BOUND LANE (S)


MILE	STATION NUMBER *
POST NUMBER	BOUND LANE (S)

NOTE: STATION NUMBERS ARE GIVEN FOR NOTED DIRECTION OF TRAVEL ONLY.
CORRESPONDING MILEPOST MARKERS FOR OTHER DIRECTION SHOULD BE PLACED DIRECTLY OPPOSITE THOSE FOR WHICH STATION NUMBERS ARE GIVEN.


IN JEFFERSON COUNTY, FINAL LOCATION OF MILEPOST MARKERS SHALL BE VERIFIED BY TRIMARC. NOTIFY TRIMARC AT LEAST TWO WEEKS PRIOR TO BEGINNING WORK

901 WEST MAIN STREET LOUISVILLE, KY 40202 502-587-6624

### PANEL SIGNS

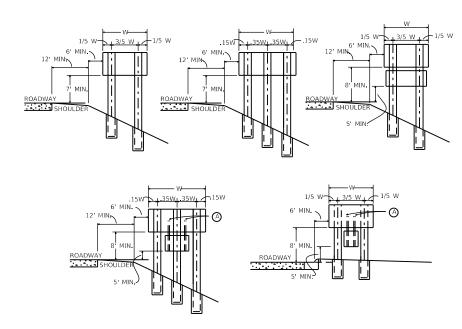


### SHEETING SIGNS

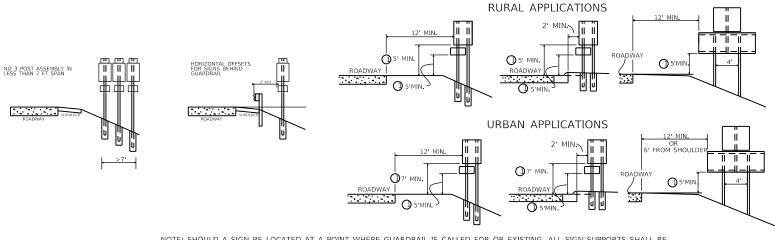

NOTE: SHOULD A SIGN BE LOCATED AT A POINT WHERE GUARDRAIL IS CALLED FOR OR EXISTING, ALL SIGN SUPPORTS SHALL BE PLACED BEHIND THE GUARDRAIL AND LATERAL OFFSET SHALL BE MEASURED FROM THE GUARDRAIL.

① NOT TO EXCEED 8' IN URBAN AREAS AND 6' IN RURAL AREAS UNLESS SPECIFIED BY THE ENGINEER

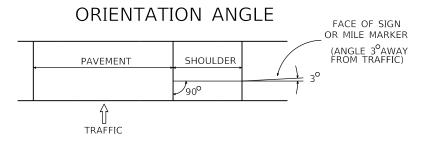


NOT TO SCALE

COMMONWEALTH OF KENTUCKY DEPARTMENT OF HIGHWAYS

OpenRoads Designer v10.16.2.267

DRAWING TITLE: SIGNING POSITIONING DETAIL SHEET

ITEM NO. 02-0935.00 COUNTY OF HENDERSON SHEET NO. R25

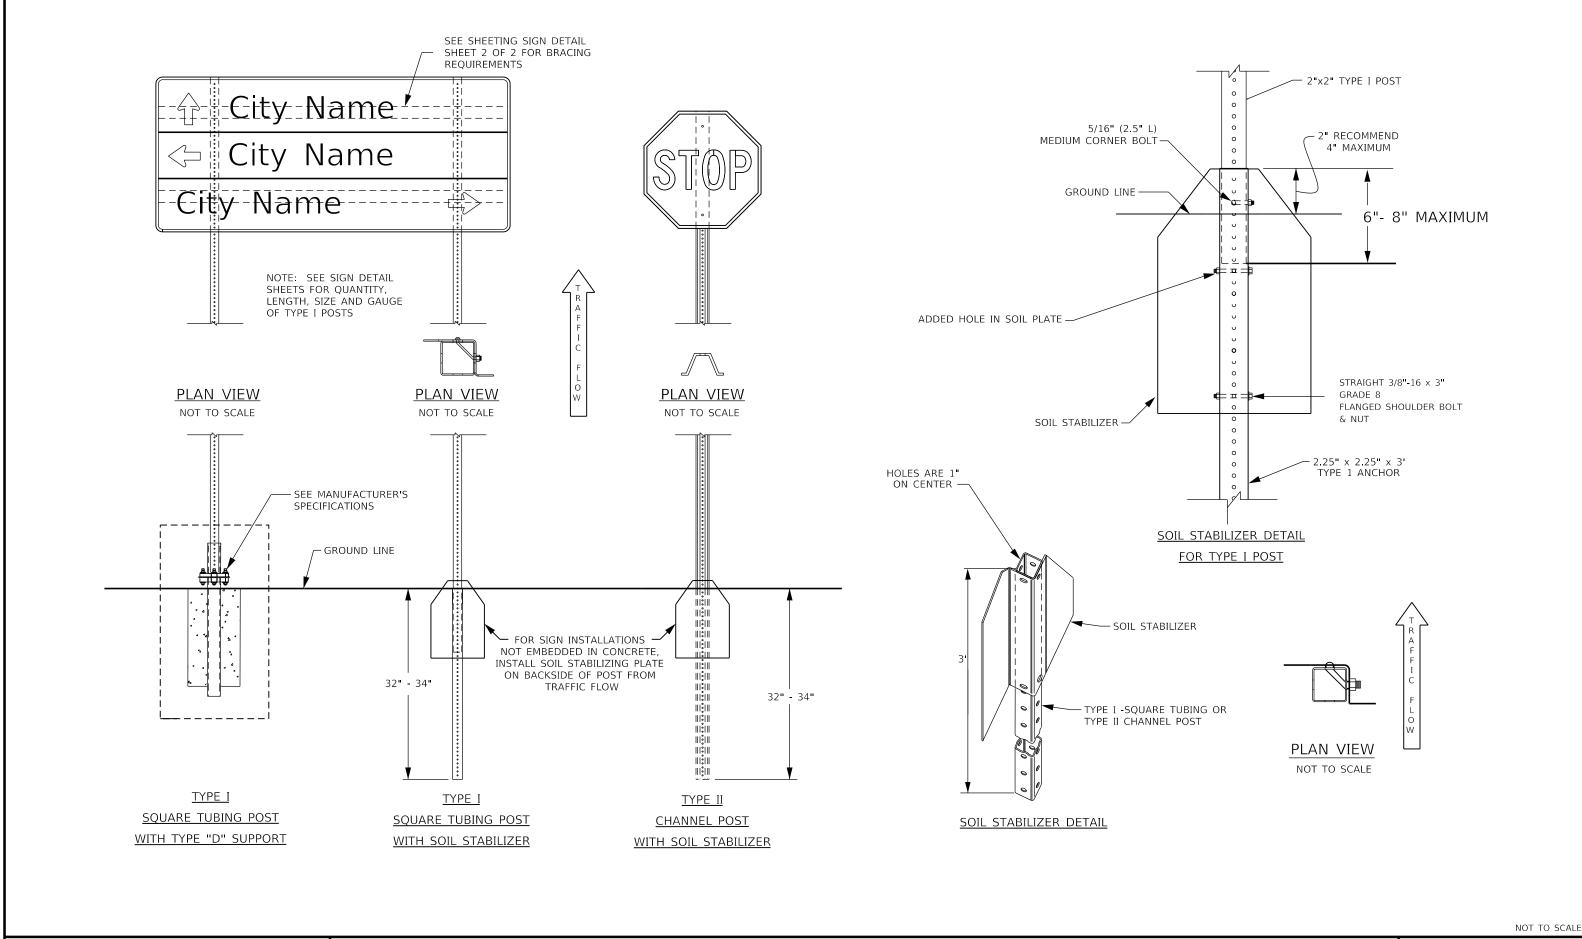

penRoads Designer v10.16.2.267

COMMONWEALTH OF KENTUCKY

DEPARTMENT OF HIGHWAYS

USER: RiceM

DRAWING TITLE: SHEETING SIGN DETAIL SHEET 1 OF 2

FILE NAME: C:\BMS\WSP-PB-US-PW-02\WSP\_MAC.RICE\D0892379\ORD SIGNING STANDARDS.DGN

TYPE I SQUARE TUBING SIGN


SUPPORT

SHEETING SIGN BRACING (SEE DETAIL THIS SHEET)

3/16" FLAT RIVET ATTACHED ON 6" CENTERS COLOR CODED TO MATCH

SIGN SHEETING

ITEM NO. 02-0935.00 COUNTY OF HENDERSON

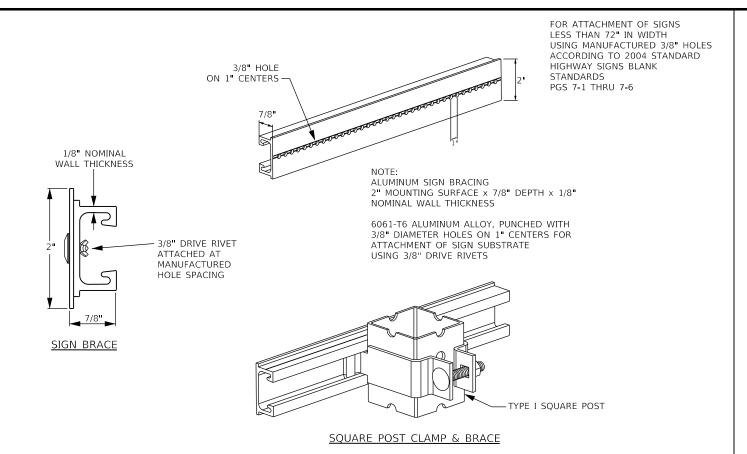

72" IN WIDTH.

FOR ATTACHMENT OF SIGNS GREATER THAN, OR EQUAL TO,

RIVETS SHALL BE COLOR CODED TO MATCH SHEETING IN ORDER TO MINIMIZE GLARE FROM RIVETS

MAX MAX. MAX. ↑ 20% MAX -SIGN BRACING (SEE DETAIL THIS SHEET) 60% MAX CONNECTING — JUNCTION 20% MAX

MAX.

2 POST - BRACING DIAGRAM

35%

MAX.

>=e = ||b =e = >=e = >=d |b =e = >=e = >=d

┝╶∊⋾╡<u>┡</u>╶∊⋷⋺∊∊⋷⋺⋵**貞**┝╶∊⋷⋺∊∊⋷⋺∊<del>┫</del>⋿⋷⋷⋺

b=c==|b=c=>=c=>=d|b=c=>=c=>=d|b=c=>:

3 POST - BRACING DIAGRAM

60%

-SIGN BRACING

(SEE DETAIL

SQUARE POST

CONNECTING-

JUNCTION

THIS SHEET)

MAX.

15% MAX

35% MAX

35% MAX

15% MAX

CHANNEL POST

TYPE I - SQUARE — SIGN POST SUPPORT

USE OF SIGN BRACING NOT SHOWN ON THIS SHEET MAY BE PERMITTED BY PROJECT ENGINEER AND/OR DISTRICT TRAFFIC ENGINEER.

NOTE:

1. MAXIMUM AREA

PER CONNECTING JUNCTION = 16 SQ. FT.

TO POST JUNCTION.

2. BRACING SHOULD NOT BE SPLICED WITHIN 6" OF A BRACE

COMMONWEALTH OF KENTUCKY DEPARTMENT OF HIGHWAYS

1/8" NOMINAL

WALL THICKNESS

SIGN BRACE

DRAWING TITLE: SHEETING SIGN DETAIL SHEET 2 OF 2

**SQUARE POST CLAMP & BRACE** 

ALUMINUM SIGN BRACING 2" MOUNTING SURFACE x 7/8" DEPTH x 1/8"

6061-T6 ALUMINUM ALLOY, PUNCHED WITH 3/16" DIAMETER HOLES ON 6" CENTERS FOR

ATTACHMENT OF SIGN SUBSTRATE USING RIVETS

NOMINAL WALL THICKNESS

FILE NAME: C:\USERS\PATRICK.STONE\DESKTOP\ORD SIGNING STANDARDS.DGN

NOT TO SCALE

### CHANNEL POST DETAILS

### TYPE "C" DRIVEN BASE TYPE "D" PIPE BASE

### PANEL DETAILS

# TYPICAL BEAM WITH TYPE "A" CONCRETE BASE DETAIL

PANEL SIGN


TOPS OF BASES TO

BE FINISHED TO

ASSURE THERE IS


TOP VIEW


FRONT VIEW

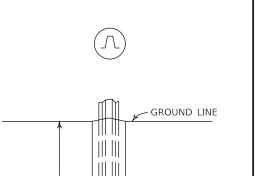


<del><11"></del>

TYPE "B" CONCRETE BASE

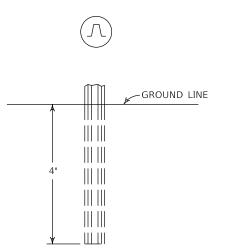

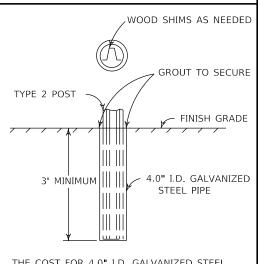


THE COST FOR 4.0" I.D. GALVANIZED STEEL PIPE FOR TYPE "D" BASE AND THE WORK FOR THE INSTALLATION SHALL BE INCLUDED IN THE BID ITEM FOR STEEL POST TYPE 2.

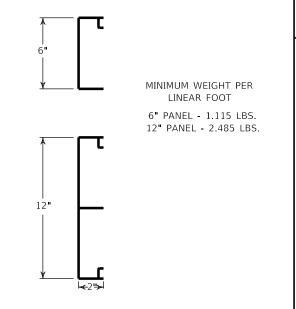



TYPICAL SECTIONS ALUMINUM SIGN PANEL EXTRUSIONS

### DETAIL FOR EXIT NUMBER SIGN ATTACHMENT AND TYPICAL POST CLIP ARRANGEMENT

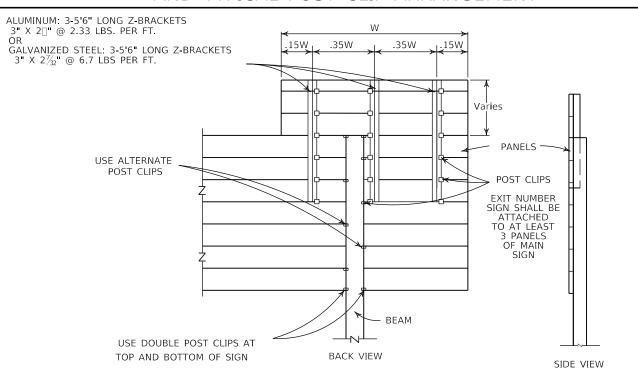

NOTE: THE COST FOR ATTACHING AN EXIT NUMBER SIGN SHALL BE INCLUDED IN THE BID ITEM FOR SIGN BASE MATERIAL FOR PANEL SIGNS AND SHALL INCLUDE ALL Z-BRACKETS AND HARDWARE. THE EXIT NUMBER SIGN SHALL BE INSTALLED OVER THE LEFT OR RIGHT SIDE OF THE SIGN AS SHOWN ON THE PLANS.

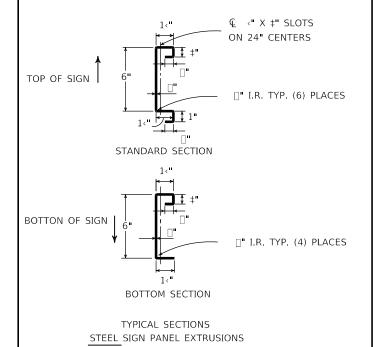

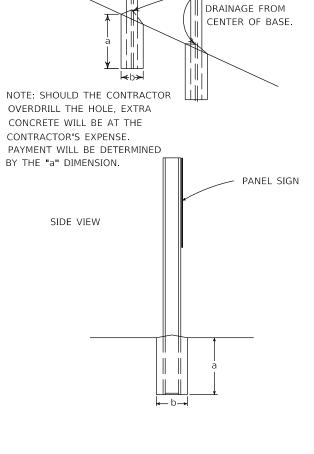


COMMONWEALTH OF KENTUCKY DEPARTMENT OF HIGHWAYS


OpenRoads Designer v10.16.2.267


DRAWING TITLE: SIGNING MISCELLANEOUS DETAIL SHEET


COUNTY OF HENDERSON ITEM NO. 02-0935.00 SHEET NO. R28

NOT TO SCALE

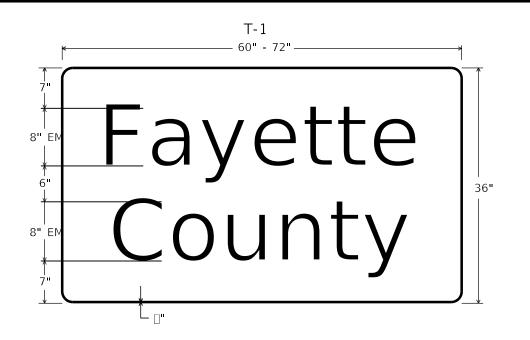

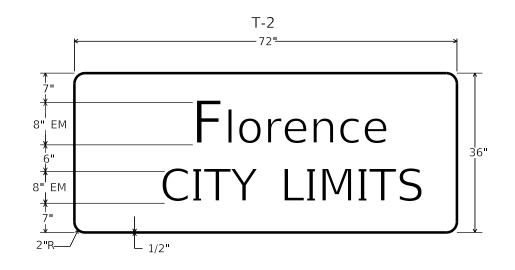

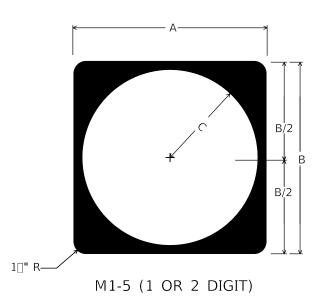

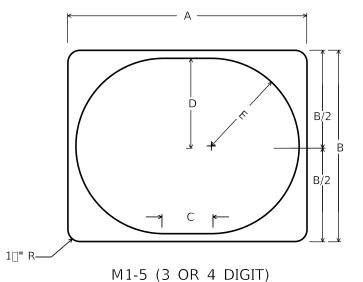

	А	В	С	FONT
CONVENTIONAL	24"	24"	11"	12D
EXPRESSWAY/ FREEWAY	36"	36"	17"	18D

	А	В		_	Е	FONT		
	А	ם	ر	U		3 DIGIT	4 DIGIT	
CONVENTIONAL	30"	24"	6"	11"	11"	12D	12B	
EXPRESSWAY/ FREEWAY	45"	36"	9"	16.5"	16.5"	18D	18B	

NOTE: FOR ROUTE MARKERS, IF NECESSARY, ADJUSTMENTS TO THE DIGIT LAYOUT AND/OR FONT TYPE MAY BE MADE TO ENSURE VISUAL ACUITY

NOTE: EXPRESSWAY/FREEWAY DEFINED AS A DIVIDED HIGHWAY WITH PARTIAL OR FULL CONTROL OF ACCESS


Ì	S-1 ← 48"—	<b>≯</b>
60"	PROHIBITED PEDESTRIANS BICYCLES MOTOR SCOOTERS METAL TREADS FARM IMPLEMENTS ANIMALS ON FOOT	*6-*-6-*******************************
3" R—	1," <sup>-</sup>	


NOT TO SCALE


COMMONWEALTH OF KENTUCKY DEPARTMENT OF HIGHWAYS

DRAWING TITLE: TYPICAL SIGNS

ITEM NO. COUNTY OF 02-0935.00 HENDERSON SHEET NO. R29

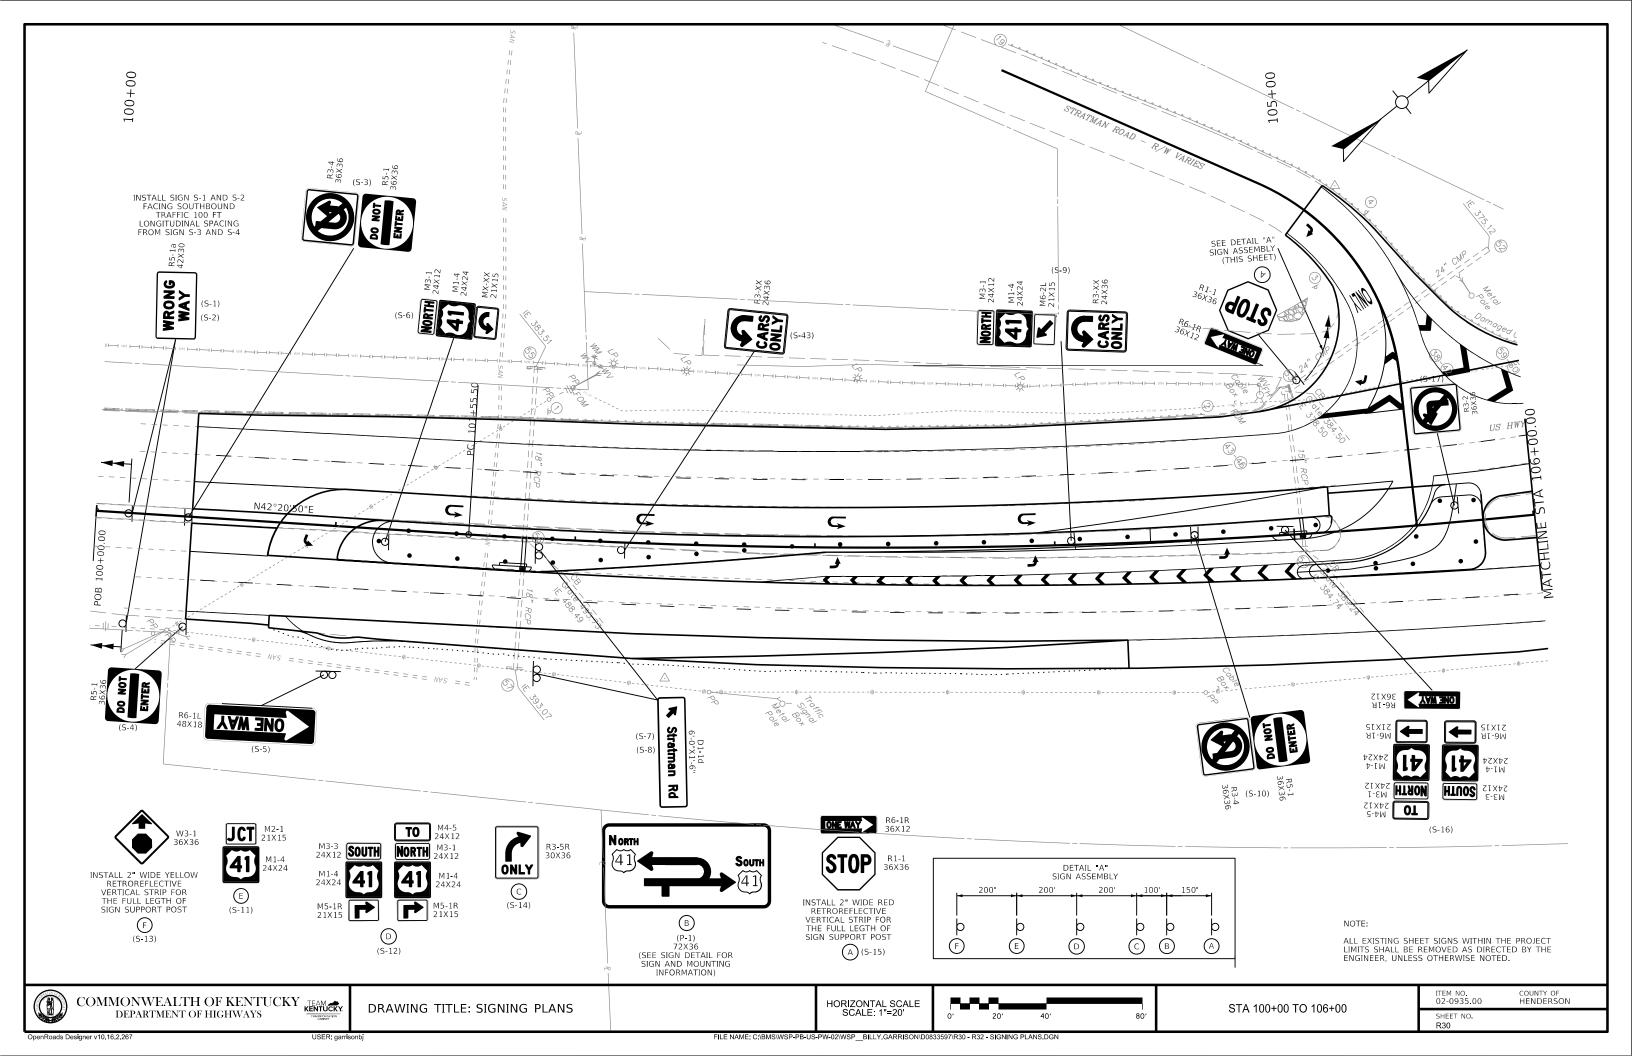

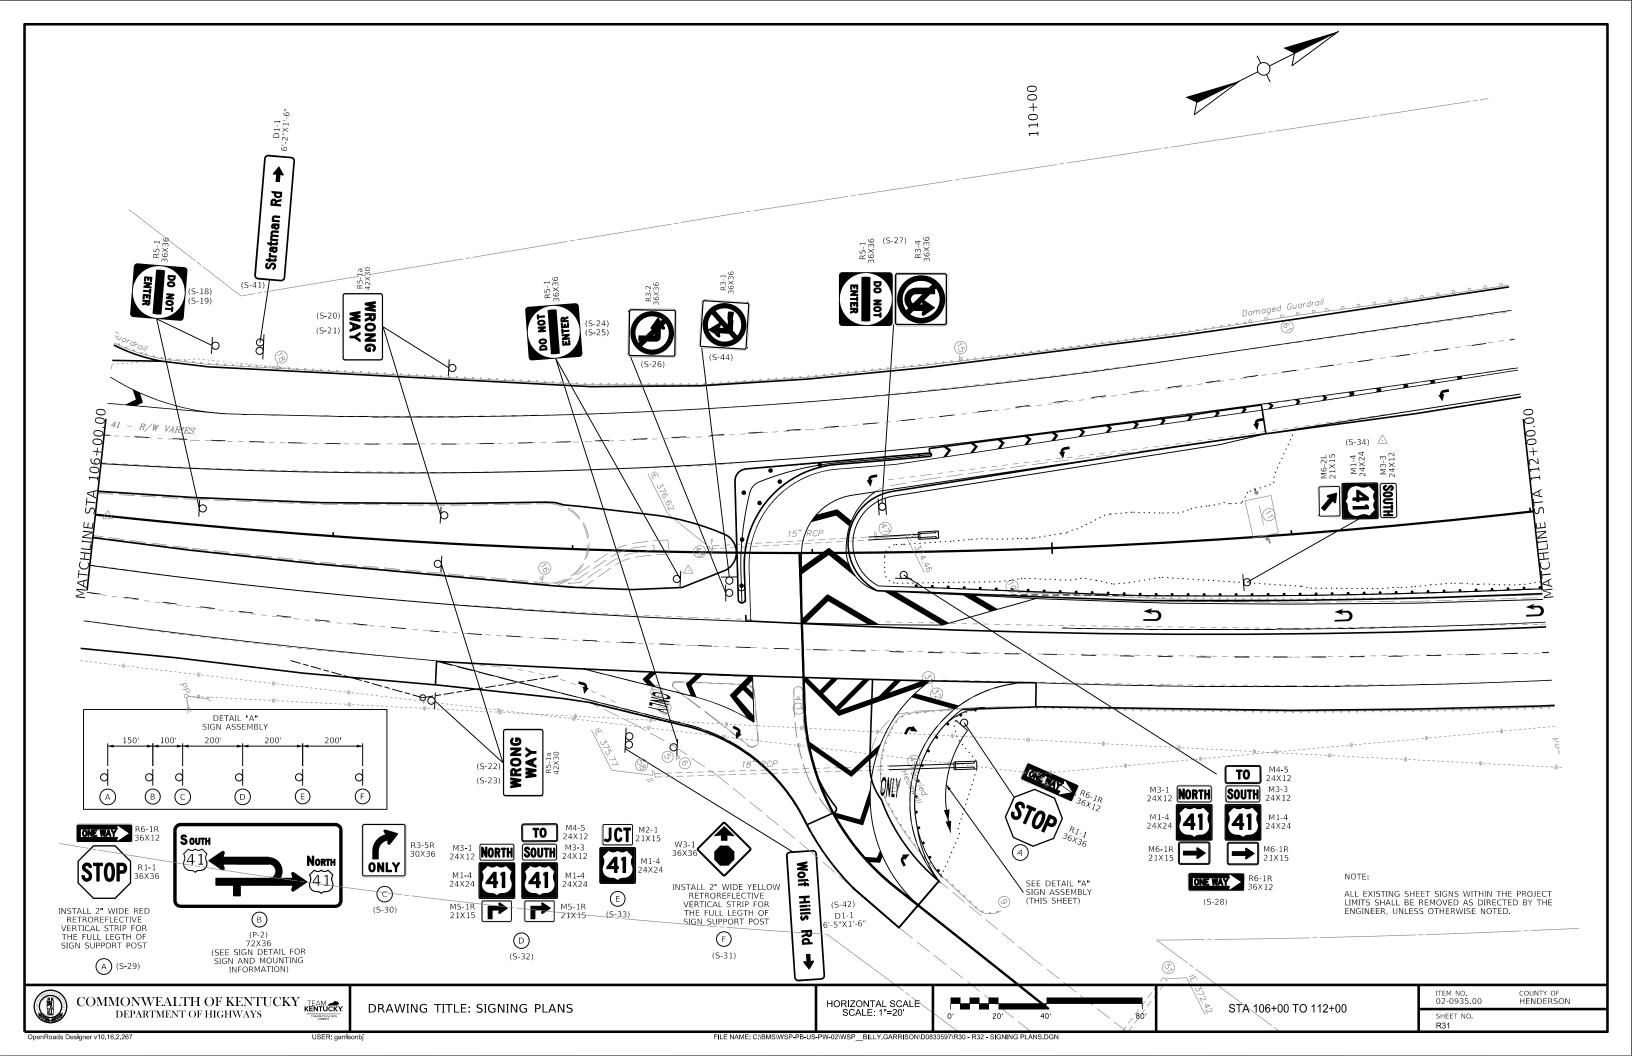

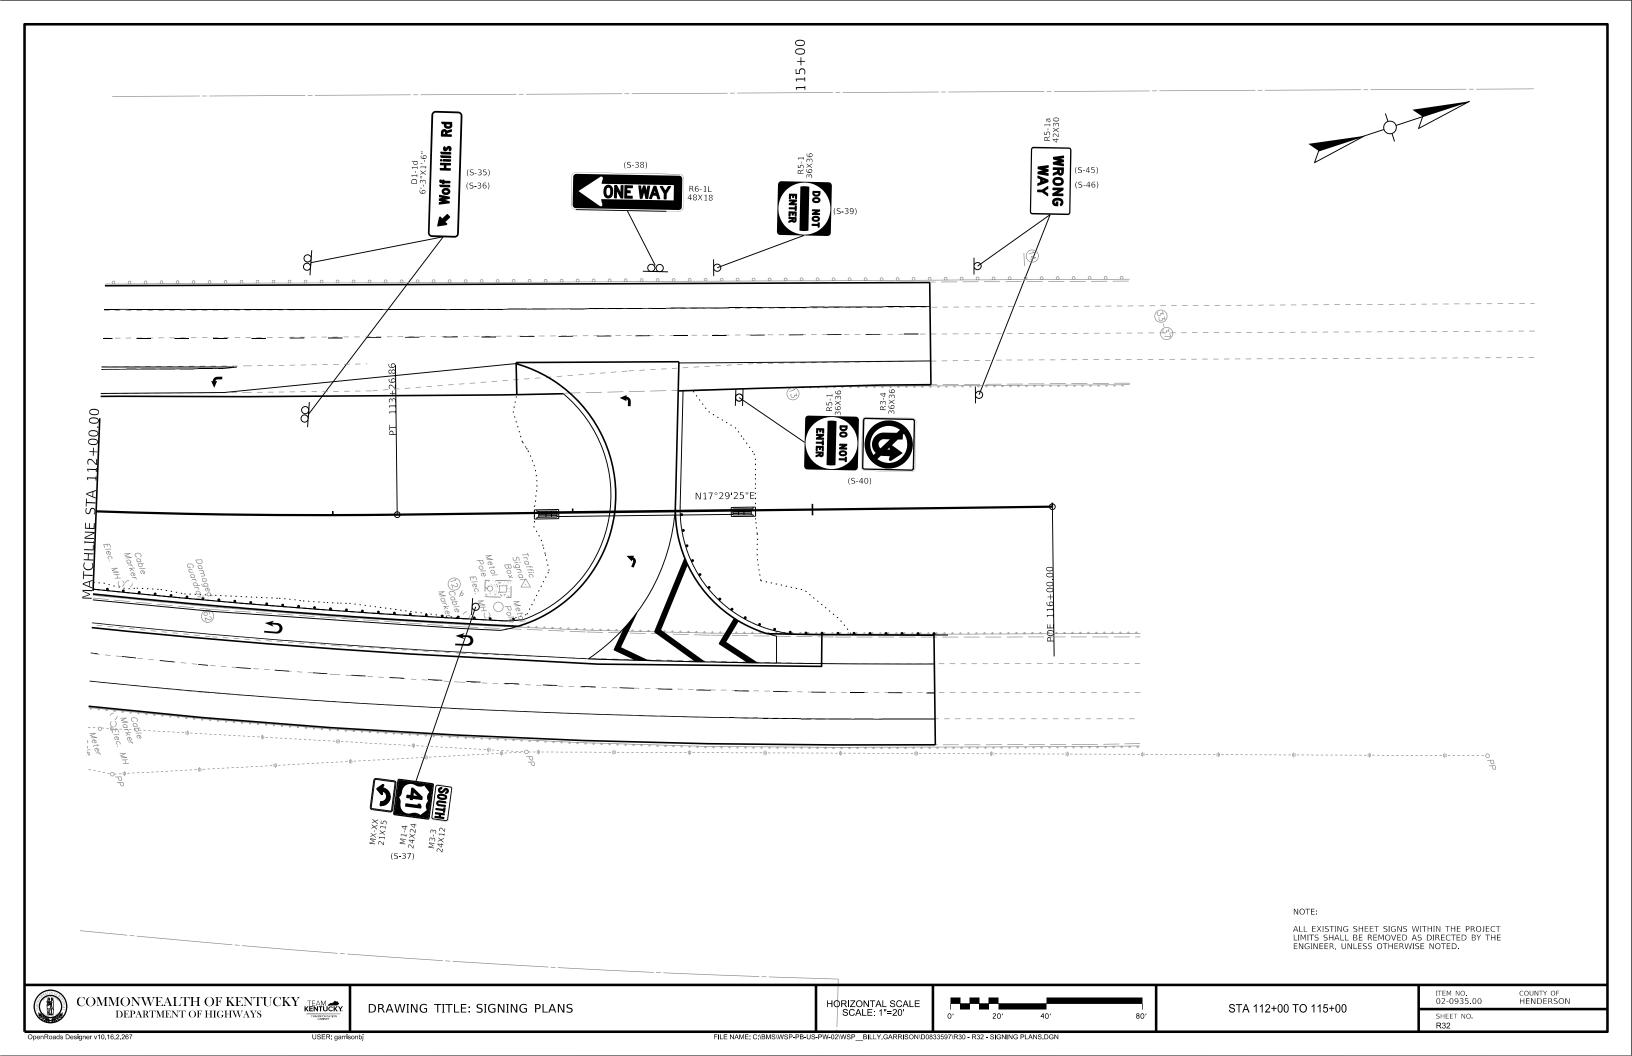

				S	HEETIN	G SIG	NS DETAIL	SHEE	Γ					COUNTY OF	ITEM NO. 02-0935.00	SHEET N
SIGN/SIGN	*SIZES				SIC	GN LOCATION		SIGN/SIGN	SIZES	<del></del>				SIGN LOCATION		RSS
ASSEMBLY NUMBER	IN INCHES HORIZ. VERT.	MESSAGES ①	SPECIFICATION	SIDE OF ROAD	FACING TRAFFIC TRAVELING	ON ROAD	AT STATION (APPROXIMATE)	ASSEMBLY NUMBER	IN INCH	ES	MESSAGES ①	SPECIFICATION	SIDE OF FACING TRAF	FIC ON ROAD		ON (APPROXIM
	42 30		R5-1a	MEDIAN	SOUTHBOUND TURNING ONTO NORTHBOUND	US 41 NORTH	100+13.00		6'-0"	1'-6"		D1-1d	MEDIAN NORTHBOU	ND US 41 NOR	гн 10:	01+86.00
S-1		WRONG						S-7			Stratman Rd					
		WAY									- Totalian ita					
					SOUTHBOUND											
	42 30		R5-1a	RIGHT	TURNING ONTO NORTHBOUND	US 41 NORTH	100+13.00		6'-0"	1'-6"		D1-1d	RIGHT NORTHBOU	ND US 41 NOR	TH 10:	01+86.00
		WDONG														
S <b>-</b> 2		WRONG						S-8			Stratman Rd					
		WAT														
	36 36		R3-4	MEDIAN	NORTHBOUND	US 41 NORTH	100+38.00		24	12	NORTH	M3-1	MEDIAN SOUTHBOU	ND US 41 SOUT	-H 104	04+06.00
	36 36		R5-1	MEDIAN	SOUTHBOUND TURNING ONTO		200.00100			24		M1-4		ND US 41 SOUT		
					NORTHBOUND					15	41	M6-2L		ND US 41 SOUT		
S-3		DO NOT						S-9	24	36		R3-XX	MEDIAN SOUTHBOU	ND US 41 SOUT	-н	
		ENTER									CARS ONLY					
	36 36		R5-1	RIGHT	SOUTHBOUND TURNING ONTO NORTHBOUND	US 41 SOUTH	100+38.00		36	36		R5-1	MEDIAN SOUTHBOU	ND US 41 SOUT	TH 104	04+56.00
					NORTHBOUND				36	36	ЕИТЕР	R3-4	MEDIAN NORTHBOU	ND US 41 NOR	гн	
6.4		DO NOT						6.10			TON OQ					
S-4		ENTER						S-10								
	48 18		R6-1L	RIGHT	SOUTHBOUND TURNING ONTO NORTHBOUND	US 41 SOUTH	101+00.00		21	15		M2-1	RIGHT EASTBOUN	D STRATMAN I	SEE SIG FOR	GNING PLA LOCATION
									24	24	<b>JCT</b>	M1-4	RIGHT EASTBOUN	D STRATMAN I	RD	
S <b>-</b> 5		ONE WAY						S-11								
											[41]					
										_					SEE SIG	GNING PL
	24 12	North	M3-1	MEDIAN	SOUTHBOUND		101+21.00			12	TO	M3-3	RIGHT EASTBOUN		FOR	LOCATIO
	24 24	NORTH	M1-4	MEDIAN	SOUTHBOUND					24	SOUTH NORTH	M1-4	RIGHT EASTBOUN			
S-6	21 15	[41]	MX-XX	MEDIAN	SOUTHBOUND	US 41 SOUTH		S-12		15		M5-1R	RIGHT EASTBOUN			
										12	41 41	M4-5 		D STRATMAN I		
										24		M3-1		D STRATMAN I		
SPECIAL NO	TEC.									15		M5-1R		D STRATMAN I		

				SHEETING SIG	NS DETAIL	SHEET	Γ						COUNTY OF HENDERSON	ITEM NO. SHEET N 02-0935.00 R34
SIGN/SIGN	*SIZES			SIGN LOCATION		SIGN/SIGN	SIZ						IGN LOCATION	
ASSEMBLY NUMBER	IN INCHES HORIZ. VERT.	MESSAGES ①	SPECIFICATION	SIDE OF FACING TRAFFIC ON ROAD  ROAD TRAVELING	AT STATION (APPROXIMATE)	ASSEMBLY NUMBER	HORIZ.	VERT.	MESSAGES ①	SPECIFICATION	ROAD	FACING TRAFFIC TRAVELING	ON ROAD	AT STATION (APPROXIM
	36 36		W3-1	RIGHT EASTBOUND STRATMAN RD	SEE SIGNING PLANS FOR LOCATION		36	36		R5-1	LEFT	NB/TURN LEFT -EASTBOUND	-US 41 NORTH -STRATMAN RD	106+45.00
									<b>A</b>					
S-13						S-19			DO NOT					
									ENTER					
	30 36		R3-5R	RIGHT EASTBOUND STRATMAN RD	SEE SIGNING PLANS FOR LOCATION		42	30		R5-1a	LEFT	NB/TURN LEFT -EASTBOUND	-US 41 NORTH -STRATMAN RD	107+45.00
S-14						S-20			WRONG					
		ONLY							WAY					
		<u> </u>												
	36 12		R6-1R	RIGHT EASTBOUND STRATMAN RD	105+05.00		42	30		R5-1a	MEDAIN -	NB/TURN LEFT -EASTBOUND	-US 41 NORTH -STRATMAN RD	107+45.00
	36 36	ONE WAY	R1-1	RIGHT EASTBOUND STRATMAN RD										
S-15						S-21			WRONG					
3 13		STOP							WAY					
	24 12	TO	M3-3	US 41 MEDIAN EASTBOUND STRATMAN RD	104+96.00		42	30		R5-1a	MEDIAN -	SB/TURN LEFT -WESTBOUND	-US 41 SOUTH -WOLF HILLS RD	107+45.00
	24 24	SOUTH NORTH	M1-4											
	21 15		M6-1R			S-22			WRONG					
S-16	24 12	41 41	M4-5						WAY					
	24 12		M3-1											
	24 24		M1-4											
	21 15	ONE WAY	M6-1R				42	30		R5-1a	RIGHT -	SB/TURN LEFT -WESTBOUND	-US 41 SOUTH -WOLF HILLS RD	107+45.00
	36 12		R6-1R											
	36 36		R3-2	MEDIAN SOUTHBOUND US 41 SOUTH	105+68.00	S-23			WRONG					
									WAY					
S-17														
							36	36		R5-1	MEDIAN -	SB/TURN LEFT -WESTBOUND	-US 41 SOUTH -WOLF HILLS RD	108+44.00
	36 36		R5-1	MEDIAN -NB/TURN LEFT -US 41 NORTH -EASTBOUND -STRATMAN RD	106+45.00	S-24			DO NOT					
S-18		DO NOT							ENTER					
		ENTER												
SPECIAL NOT 1. COLORS F	OR SIGN ASSE	MBLIES ARE DESIGNATED IN THE "MAN	UAL ON UNIFORM TRAFFIC CONTROL D	DEVICES" AND "STANDARD HIGHWAY SIGNS" R THAN 36" (THIRTY-SIX INCHES), OTHERWISE 0.08	0.60465.447520	DE 11653								


				S	HEETIN	NG SIGN	IS DETAIL !	SHEET	-					COUNTY OF HENDERSON	02-0935.00	SHE
GN/SIGN SSEMBLY IUMBER	*SIZES IN INCHES	MESSAGES ①	SPECIFICATION	SIDE OF	FACING TRAFFIC	ON ROAD	AT STATION (APPROXIMATE)	SIGN/SIGN ASSEMBLY NUMBER	SIZES IN INCHES	MESSAGES ①	SPECIFICATION	SIDE OF	FACING TRAFFIC	SIGN LOCATION ON ROAD	AT STATION (	(APPR
IOMBEK	HORIZ. VERT.		R5-1	ROAD	TRAVELING -SB/TURN LEFT	-US 41 SOUTH	108+44.00	NOMBER	HORIZ. VERT.		W3-1	ROAD	TRAVELING WESTBOUND	WOLF HILLS RD	SEE SIGNII FOR LO	ING
-		_		1,,,,,,,,,,,,,,,,,,,,,,,,,,,,,,,,,,,,,,	-WESTBOUND	-WOLF HILLS RD	200111100			_		11.0111			FOR LO	CA
-		DO NOT														
S-25		ENTER						S-31								_
-																_
-																_
	36 36		R3-2	MEDIAN	NORTHBOUND	US 41 NORTH	108+65.00		24 12	ТО	M3-1	RIGHT	WESTBOUND	WOLF HILLS RD	SEE SIGNII FOR LO	JIN OC
Ī									24 24	NORTH SOUTH	M1-4	RIGHT	WESTBOUND	WOLF HILLS RD		
Ī									21 15	NOKTH SOUTH	M5-1R	RIGHT	WESTBOUND	WOLF HILLS RD		
5-26								S-32	24 12	[41] [41]	M4-5	RIGHT	WESTBOUND	WOLF HILLS RD		
									24 12		M3-3	RIGHT	WESTBOUND	WOLF HILLS RD		
Ì									24 24 21 15		M1-4 M5-1R	RIGHT RIGHT		WOLF HILLS RD		_
	36 36		R3-4	MEDIAN	SOUTHBOUND	US 41 SOUTH	109+30.00		21 15		M2-1	RIGHT		WOLF HILLS RD		_
-	36 36		R5-1	MEDIAN	NORTHBOUND	US 41 NORTH			24 24		M1-4	RIGHT	WESTBOUND	WOLF HILLS RD	SEE SIGNII FOR LO	IN
-										<u>JCT</u>					1011 20	_
5-27								S-33								_
-		DO NOT														_
-		ENTER														
	24 12	ТО	M3-1	US 41 MEDIAN	WESTBOUND	WOLF HILLS RD	109+38.00		24 12		M3-3	MEDIAN	NORTHBOUND	US 41 NORTH	110+8	⊦8
	24 24	NORTH SOUTH	M1-4						24 24	SOUTH	M1-4	MEDIAN	NORTHBOUND	US 41 NORTH		
	21 15		M6-1R					S-34	21 15		M6-2L	MEDIAN	NORTHBOUND	US 41 NORTH		
S-28	24 12	[41] [41]	M4-5					3-34		41)						
5-20	24 12		M3-3													
	24 24		M1-4													
	21 15	ONE WAY	M6-1R						6'-3" 1'-6"		D1-1d	MEDIAN	SOUTHBOUND	US 41 SOUTH	112+8	⊦8
	36 12	ONL NAT	R6-1R													_
	36 12		R6-1R	RIGHT	WESTBOUND	WOLF HILLS RD	109+60.00	6.35		R Well Little D4						
ļ	36 36	ONE WAY	R1-1	RIGHT	WESTBOUND	WOLF HILLS RD		S-35		<b>▼ Wolf Hills Rd</b>						
5 20																_
5-29																
									6'-3" 1'-6"		D1-1d	LEFT	SOUTHBOUND	US 41 SOUTH	112+8	-8
																_
	30 36		R3-5R	RIGHT	WESTBOUND	WOLF HILLS RD	SEE SIGNING PLANS FOR LOCATION	S-36		<b>▼ Wolf Hills Rd</b>						
S-30								3-30		שא פוווח ווטא די						
J-30		ONLY														
Ī		CHLI														


	SHEETING SIGNS DETAIL SHEET														COUNTY OF	ITEM NO. SHEET NO.			
											SIZ	HENDERSON 02-0935.00 R36 SIGN LOCATION							
	SIGN/SIGN ASSEMBLY NUMBER	/ IN INC	HES	MESSAGES ①	SPECIFICATION	SIDE OF ROAD	FACING TRAFFIC TRAVELING		AT STATION (APPROXIMATE)	SIGN/SIGN ASSEMBLY NUMBER	IN IN		MESSAGES ①	SPECIFICATION	SIDE OF FACING TE ROAD TRAVEL	AFFIC ON BOAD	AT STATION (APPROXIMATE)		
		24	12		M3-3	MEDIAN	NORTHBOUND	US 41 NORTH	113+59.00		24	36	2'-0"	R3-XX	MEDIAN SOUTHBO	UND US 41 SOUTH	102+21.00		
		24	24	SOUTH	M1-4	MEDIAN	NORTHBOUND	US 41 NORTH					12.8"						
	S-37	21	15	41	MX-XX	MEDIAN	NORTHBOUND	US 41 NORTH		5-43			CARS 6.00						
	33,																		
													BORDER 1.5" 20.3" 1.8						
													BORDER 19 20.3 1/8 R=1.15 1H-0.63 Panel Style: regulatory.ssi N=0.38 M.U.T.C.D.: 2009 Edition		COUTUR	LINIS			
NDC		48	18		R6-1L	LEFT	NORTHBOUND TURNING ONTO SOUTHBOUND	US 41 NORTH	114+36.00		36	36		R3-1	MEDIAN TURNING EASTBO	UND ONTO US 41 SOUTH JND	108+65.00		
DETAILS.I																			
ING DE	S-38			ONE WAY						S <b>-</b> 44									
- SIGN																			
3 - R38																			
597\R33							NORTHROUND								NORTHRO	LIND			
\D0833		36	36		R5-1	LEFT	TURNING ONTO	US 41 NORTH	114+62.00		42	30		R5-1a	LEFT TURNING SOUTHBO	UND ONTO US 41 NORTH UND	115+70.00		
C.RICE																			
SP_MA	S-39			DO NOT						S-45			WRONG						
V-02\W				ENTER									WAY						
B-US-P\																			
3/WSP-P			_												NORTHBO	UND			
C:\BMS		36	36		R3-4	MEDIAN		US 41 SOUTH	114+70.00		42	30		R5-1a	MEDAIN TURNING SOUTHBO	UND ONTO UND US 41 NORTH	115+70.00		
NAME		36	36		R5-1	MEDIAN	SOUTHBOUND	US 41 NORTH					WDONO						
FILE	S-40									S-46			WRONG						
				DO NOT									WAY						
				ENTER															
2005		6'-2 <b>"</b>	1.6		D1-1	LEFT	SOLITHBOLIND	US 41 SOUTH	106+62.00										
nber 7,		0 -2	1-0		D1-1		JOOTTIBOOND	03 41 300111	100+02.00										
Septen																			
seM OTTED:	S <b>-</b> 41		$\dashv$	Stratman Rd →						S-X									
USER: RICEM DATE PLOTTED:			$\dashv$																
ň å			$\overline{}$																
		6'-5"	1'-6"		D1-1	RIGHT	NORTHBOUND	US 41 NORTH	108+25.00										
			$\dashv$																
			$\overline{}$	(m. 40 4000 - 1 1 1															
	S-42			Wolf Hills Rd →						S-X									
6.2.267																			
r v10.1																			
Sesigne	SPECIAL NO	TES: FOR SIGN	V ASSEN	BLIES ARE DESIGNATED IN THE "M.	ANUAL ON UNIFORM TRAFFIC CONTROL DEV	ICES" AND "STA	NDARD HIGHWA	Y SIGNS"			1			ı		ı	1		
ads [	2. SHEETING	G SIGNS	SHALL E	E FABRICATED FROM 0.125 GUAGE	ANUAL ON UNIFORM TRAFFIC CONTROL DEV MATERIAL IF ANY DIMENSION IS GREATER T	THAN 36" (THIRT	Y-SIX INCHES), (	OTHERWISE 0.080	GUAGE MATERIAL SHALL E	BE USED.					CHEE	INC CICNC DE	TAIL CLIEFT		

COUNTY OF	ITEM NO.	SHEET NO.
HENDERSON	02-0935.00	R37

# SIGN DETAIL

N.T.S.

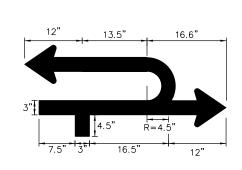

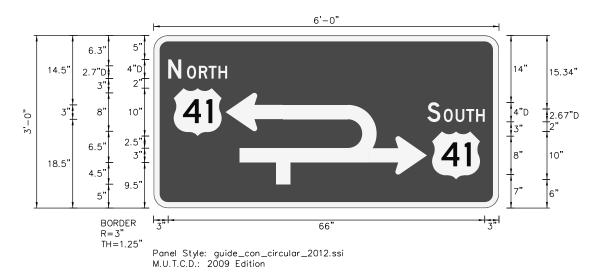

SIGN LOCATION & MOUNTING INFORMATION												
SIDE OF ROAD		FFIC CTION		ON OAD	MIL	E POINT						
RIGHT	EAST	BOUND		ATMAN DAD		**						
MOUNTING	STYLE		GF	ROUND								
POST SIZE			TY	PE 1 P	OST							
POST 1 LEN	IGTH =		15'		ONTAL							
POST 2 LEN	IGTH =		15'	CLEAF	RANCE							
POST 3 LEN	IGTH =		15'	_T.	12' RT.							
TYPE "D" BREAKAWAY SIGN SUPPORT 3 EACH												
CONCRETE BASE DIMENSIONS												
a = 1'-6" DIA. b = 3'-6" 0.25 Cu. Yds./Post												

**						
1.7.NC	)TF · 9	SFF	SIGNING	PLANS	FOR	LOCATION
110	, ı L		SICIVIIVO	1 1 11	1 011	LOC/ TION

P–1
6'-0" x 3'-0"
1.25"
3"
GROUND
TYPE: Reflective
COLOR: Green
TYPE: Reflective
COLOR: White/White

SYMBOL	ROT	Х	Υ	WID	HT
AR_Type D	90	15	16	8	12
M1_4	0	4,2	15	10	10
AR_Type D	270	45	7	8	12
M1_4	0	58	6	10	10
				·	·

Panel Style: guide\_con\_circular\_2012.ssi
Dimensions are in inches.tenths


Letter locations are panel edge to lower left corner


																LENGTH	H SERIES/SIZE				
N	0	R	T	Н																	D 2000
3	7	9.4	11.5	13.5																12.3	4,2.7
S	0	U	Ţ	Н																	D 2000
57.1	60.5	63	65.2	67.2																12	4,2.7

COUNTY OF	ITEM NO.	SHEET NO.
HENDERSON	02-0935.00	R38

# SIGN DETAIL

N.T.S.

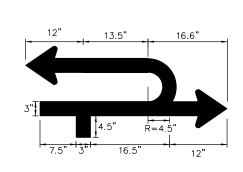

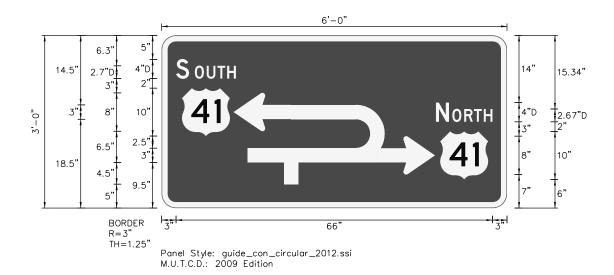

SIGN LOCATION & MOUNTING INFORMATION												
SIDE OF ROAD		AFFIC ECTION		ON OAD	MILI	E POINT						
RIGHT	WEST	BOUND		HILLS RIVE		**						
MOUNTING	STYLE		GF	ROUND								
POST TYPE			TY	OST								
POST 1 LEN	IGTH =		15'		LATICE							
POST 2 LEN	IGTH =		15'	-	CLEAR	RANCE						
POST 3 LEN	IGTH =		15'	.Т.	12' RT.							
TYPE "D" BREAKAWAY SIGN SUPPORT 3 EACH												
CONCRETE BASE DIMENSIONS												
a = 1'-6" DIA. b = 3'-6" 0.25 Cu. Yds./Post												

**					
""NOTF	SFF	SIGNING	PLANS	FOR	LOCATION
11016		SICIVIIVO	1 4 1113	1 011	

SIGN NUMBER	P-2								
WIDTH x HGHT.	6'-0" x 3'-0"								
BORDER WIDTH	1.25"								
CORNER RADIUS	3"								
MOUNTING	GROUND								
BACKGROUND	TYPE: Reflective								
	COLOR: Green								
LEGEND/BORDER	TYPE: Reflective								
	COLOR: White/White								

SYMBOL	ROT	Χ	Υ	WID	HT
AR_Type D	90	15	16	8	12
M1_4	0	4.2	15	10	10
AR_Type D	270	45	7	8	12
M1_4	0	58.1	6	10	10

Panel Style: guide\_con\_circular\_2012.ssi
Dimensions are in inches.tenths

Letter locations are panel edge to lower left corner

	LETTER POSITIONS (X)															LENGTH	H SERIES/SIZE				
S		0	U	T	Н																D 2000
3		6.9	9.4	11.6	13.7															12.5	4,2.7
N		0	R	T	Н																D 2000
57.	2	60.6	63.1	65.1	67.2															11.8	4,2.7

DRAWING TITLE: STRIPING PLANS

HORIZONTAL SCALE SCALE: 1"=20'

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— WHITE CHEVRONS 12" AT 10' SPACING

STA 100+00 TO 106+00

ITEM NO. 02-0935.00 COUNTY OF HENDERSON SHEET NO. R39

WHITE CHEVRONS — 24" AT 20' SPACING

-6" SSWL

6" SDWL 10x30 —

6" SSYL —

6" SDWL 10x30

-6" DSYL

105+00

6" SSWL -

6" DSYL —

YELLOW CHEVRONS -24" AT 20' SPACING

── 6" SSWL

−6" SSWL


US 41	100+88.18	6.56'RT	LEFT TURN ARROW
US 41	103+11.91	8.06' RT	LEFT TURN ARROW
US 41	103+91.67	7.23' RT	LEFT TURN ARROW
US 41	104+71.47	6.65' RT	LEFT TURN ARROW
US 41	101+53.02	9.72' LT	U-TURN ARROW
US 41	102+33.12	10.11' LT	U-TURN ARROW
US 41	103+13.23	10.67' LT	U-TURN ARROW
US 41	103+92.77	11.40' LT	U-TURN ARROW
STRATMAN RD	201+47.21	5.35' RT	LEFT TURN ARROW
STRATMAN RD	201+80.55	6.67' RT	"ONLY"
STRATMAN RD	202+22.10	16.05' RT	LEFT TURN ARROW
STRATMAN RD	202+34.19	15.42' RT	24" STOP BAR - 19 LF

100+00

THERMOPLASTIC CHEVRONS				
ALIGNMENT	STATION	OFFSET	DESCRIPTION	
US 41	104+04	13' RT	WHITE CHEVRONS - 118 SQFT	
STRATMAN RD	202+12	5' RT	YELLOW CHEVRONS - 49 SQFT	
STRATMAN RD	202+23	31' LT	WHITE CHEVRONS - 108 SQFT	

	6" SSWL					6" SSWL —
		 6" SSYL	_	/L 10×30		6" SDWL 10x30
	6" SS	SYL SYL	6" SSWL	ſ─6" SSYL <b>Ç</b>	¢	6" SSWL
_	6" 9	 5DWL 10.	x30	6" SSYL		
6" SSWL						6" SSWL
ті	HERMOPLA	ASTIC MA	ARKINGS	6" SSWL —— 6" SINGLE SO	OLID WHITE LINE (PAID	FOR BY FD05)
ALIGNMENT	STATION	OFFSET	DESCRIPTION	6" SSYL — 6" SINGLE S	OLID YELLOW LINE (PAIL	D FOR BY FD05)
US 41	100+88.18	6.56'RT	LEFT TURN ARROW	6" SDWL 10x30 — 6" SINGLE D	ASHED WHITE LINE 10x	30 SPACING (PAID FOR BY FD05)
US 41	103+11.91	8.06' RT	LEFT TURN ARROW			
US 41	1	7.23' RT	LEFT TURN ARROW	6" DSYL —— 6" DOUBLE S	SOLID YELLOW LINE (PA	ID FOR BY FD05)
US 41	103+91.67					
1	103+91.67	6.65' RT	LEFT TURN ARROW			
US 41			LEFT TURN ARROW U-TURN ARROW			
US 41 US 41	104+71.47	9.72' LT				
	104+71.47 101+53.02	9.72' LT 10.11' LT	U-TURN ARROW			
US 41	104+71.47 101+53.02 102+33.12	9.72' LT 10.11' LT 10.67' LT	U-TURN ARROW U-TURN ARROW	THERMOPLASTIC	CHEVRONS	

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OpenRoads Designer v10.16.2.267 FILE NAME: C:\BMS\WSP-US-PW-02\D0833597\R39 - R41 - STRIPING PLANS.DGN

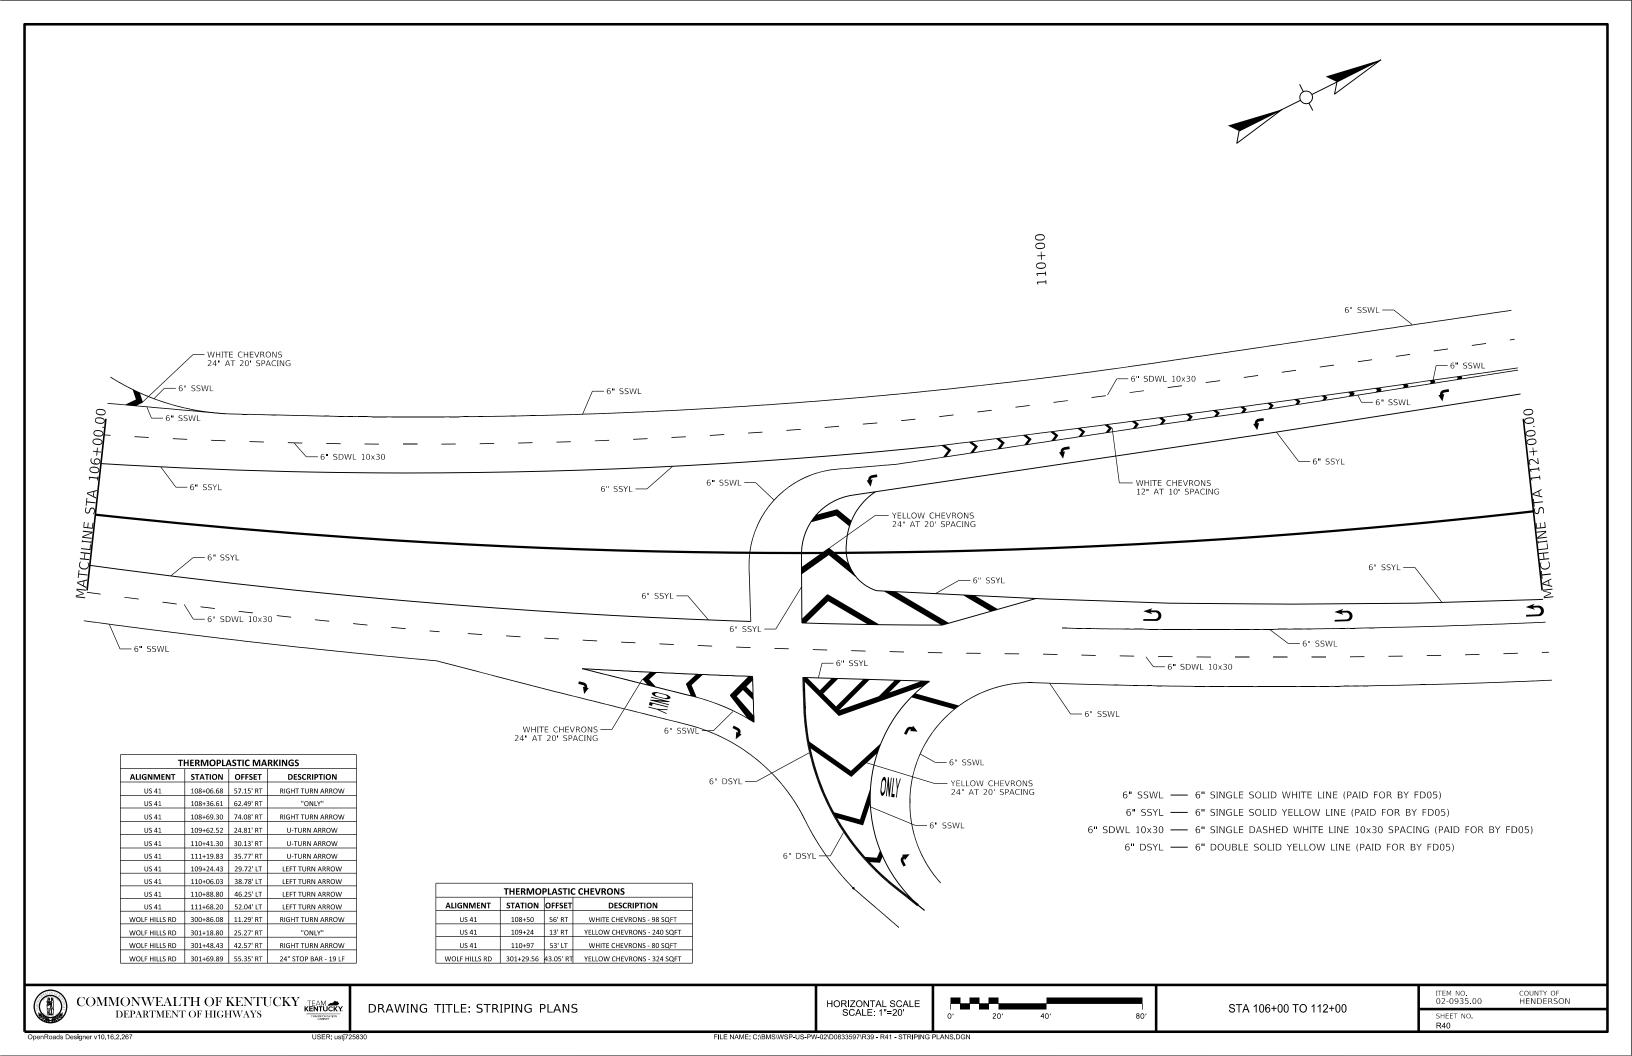HORIZONTAL SCALE SCALE: 1"=20'

STA 112+00 TO 115+00

ITEM NO. 02-0935.00

COUNTY OF HENDERSON

THERMOPLASTIC MARKINGS ALIGNMENT STATION OFFSET DESCRIPTION 6" SDWL 10x30 — 6" SINGLE DASHED WHITE LINE 10x30 SPACING (PAID FOR BY FD05) 112+76.64 47.21' RT U-TURN ARROW US 41 113+55.28 52.82' RT U-TURN ARROW US 41 114+24.35 20.61' RT LEFT TURN ARROW THERMOPLASTIC CHEVRONS ALIGNMENT STATION OFFSET US 41 114+42 46' RT YELLOW CHEVRONS - 209 SQFT

-6" SSWL ∕— 6" SSWL -6" SDWL 6" SSWL -6" SSYL 1 112 + 00.006" SSYL -── 6" SSWL N17°29'25"E -6" SSYL 6" SSYL — YELLOW CHEVRONS 24" AT 20' SPACING **5** -6" SSYL 6" SSWL — 6" SDWL V—6" SDWL 6" SSWL --6" SSWL

> 6" SSWL — 6" SINGLE SOLID WHITE LINE (PAID FOR BY FD05) 6" SSYL — 6" SINGLE SOLID YELLOW LINE (PAID FOR BY FD05)

6" DSYL — 6" DOUBLE SOLID YELLOW LINE (PAID FOR BY FD05)

COMMONWEALTH OF KENTUCKY LEAVER DEPARTMENT OF HIGHWAYS DRAWING TITLE: STRIPING PLANS

115+00

## ROADWAY LIGHTING ESTIMATE OF QUANTITIES

TOTAL	UNITS	CODE	TEM DESCRIPTION
5	EACH	4701	POLE 40' MTG HT
5	EACH	4725	BRACKET 15'
5	EACH	4740	POLE BASE
5	EACH	4750	TRANSFORMER BASE
1	EACH	4761	LIGHTING CONTROL EQUIPMENT
10	EACH	4780	FUSED CONNECTOR KIT
1120	LIN FT	4797	CONDUIT 3 INCH
2	EACH	4800	MARKER
4145	LIN FT	4820	TRENCHING AND BACKFILLING
825	LIN FT	4832	WIRE - NO. 12
3025	LIN FT	4860	CABLE - NO. 8/3C DUCTED
8	EACH	20391NS83	5 ELECTRICAL JUNCTION BOX TYPE A
5	EACH	24589ED	LED LUMINAIRE

THE STANDARD SPECIFICATIONS FOR ROAD AND BRIDGE CONSTRUCTION, CURRENT EDITION, AND OTHER SPECIAL NOTES AND SPECIFICATIONS WILL APPLY ON THIS PROJECT. SEE SECTION 716 FOR MEASUREMENT AND OTHER DETAILS. SEE SECTION 602 FOR SPIRAL REINFORCEMENT SPLICING

THE CONTRACTOR SHALL MAKE AN INSPECTION OF THE PROJECT SITE PRIOR TO SUBMITTING A BID AND SHALL BE THOROUGHLY FAMILIARIZED WITH EXISTING CONDITIONS. SUBMISSIONS OF A BID WILL BE CONSIDERED AN AFFIRMATION OF THIS INSPECTION HAVING BEEN COMPLETED.

ADD SENTENCE TO SECTION 834.06: ALL WIRE SHALL HAVE WORDING ADDED TO THE OUTER JACKET THAT STATES: " PROPERTY OF KENTUCKY TRANSPORTATION CABINET 502 564

ADD SENTENCE TO SECTION 834.09: ALL WIRE SHALL HAVE WORDING ADDED TO THE OUTER JACKET THAT STATES: " PROPERTY OF KENTUCKY TRANSPORTATION CABINET 502 564 0501".

CONSTRUCTION AND MEASUREMENT NOTES THAT ARE CONTRARY TO SECTION 716 AND 834

716.03.03 TRENCHING. SUBSECTION:

REMOVE: REMOVE SENTENCE UNDER B); NO PAYMENT FOR ADDITIONAL JUNCTION BOXES FOR GREATER DEPTHS WILL BE

ALLOWED

SUBSECTION: 716.03.04 CONDUIT INSTALLATION

ADD TO SECOND SENTENCE WITH THE FOLLOWING: BASES WITH BREAKWAY DEVICES INSTALLED. REVISION:

SUBSECTION:

REVISION:

716.03.04 (K) BORE AND JACK.
REPLACE TITLE WITH THE FOLLOWING: BORE AND JACK/OPEN CUT ROADWAY
ADD SENTENCES AFTER LAST SENTENCE: WITH PERMISSION OF THE ENGINEER, ROADWAY MAY BE OPEN CUT IF
CONDUIT IS UNDER PAVEMENT. THE CONDUIT IN OPEN CUT CAN BE EITHER 2" RIDID STEEL OR SCHEDULE 80 PVC UNDER ALL PAVEMENTS AREAS. IF IT IS THE LOOP TRANSITION FROM THE SAW SLOT, IT SHALL BE RIGID STEEL.

SUBSECTION: 834.15.03 TRANSFORMER BASES.

REMOVE SENTENCE: CONSTRUCT THE DOOR OF A HIGH DENSITY POLYETHYLENE MATERIAL IN COLOR THAT REMOVE:

MATCHES THE BASE.

**REVISION:** REPLACE THE FOLLOWING SENTENCE WITH THE FOLLOWING:

CONSTRUCT THE DOOR OF AN ALUMINUM MATERIAL IN A COLOR THAT MATCHES THE BASE. THE DOOR SHOULD HAVE A THEFT DETERRENT DEVICE THAT IS EQUAL TO THE LOCKDOWN LIGHTLOCK DOOR ASSEMBLY. THE DOOR LOCK WILL HAVE A LOCKING DEVICE WITH A KYTC CUSTOM KEY THAT WILL BE SEND TO CENTRAL OFFICE TRAFFIC OPERATIONS FROM THE MANUFACTURER AND BE ISSUED TO THE CONTRACTOR FOR THE INSTALLATION OF THE FINAL DOOR DEVICE. THE KEY FOR THE DOOR SHALL BE RETURNED TO CENTRAL OFFICE TRAFFIC OPERATIONS AFTER THE CLOSURE OF THE CONTRACT. THERE SHALL BE A 4" BY 6" ARC FLASH WARNING STICKER INSTALLED CENTER TOP OF EACH DOOR. THE STICKER SHALL BE METALCRAFT PLY695 PREM STYLEMARK LABEL WITH .007 THICKNESS, WITH UV WHITE POLYCARBINATE MATERIAL, AND WITH MC53FL PRESSURE SENSITIVE ADHESIVE. THE STICKER SHALL HAVE TWO COLORS OF BLACK AND CUSTOM COLOR ORANGE. THE WORDING FOR THE ARC FLASH STICKER SHALL BE THE FOLLOWING: "WARNING ARC FLASH HAZARD. APPROPRIATE PPE REQUIRED. FAILURE

TO COMPLY CAN RESULT IN DEATH OR INJURY. REFER TO NFPA 70E."

SECTION: 834.15 LIGHTING POLES.

**REVISION:** 

ADD THE FOLLOWING TO THE FIRST PARAGRAGH: THE CABINET WILL WAIVE THE REQUIREMENT STATED IN THE FIRST SENTENCE OF SECTION 5.14.6.2 - REINFORCED

HOLES AND CUTOUT FOR HIGH MAST POLES (ONLY).

SECTION: 834.33 WARNING TAPE.

REPLACE FIRST SENTENCE WITH THE FOLLOWING: **REVISION:** 

PROVIDE DETECTABLE TYPE TAPE THAT IS 6 INCHES WIDE AND 7.0 MILS (NOMINAL)THICK.

MEASUREMENT NOTE THAT ARE IN ADDITION TO SECTION 716:


WIRE OR CABLE SHALL INCLUDE INSTALLING SPECIFIED WIRE OR CABLE WITHIN CONDUIT AS INDICATED ON THE PLAN SHEETS. INCIDENTAL TO THIS ITEM SHALL BE THE FURNISHING AND INSTALLING OF SPLICE BOOTS OR ANY OTHER HARDWARE REQUIRED FOR INSTALLING CABLE. THE CONTRACTOR SHALL INSTALL ALL CABLE OR WIRE RUNS SPLICE-FREE FROM THE CONTROLLER TO EACH POLE THE CABLE OR WIRE IS FEEDING. EXCEPTIONS TO THIS MUST BE APPROVED BY THE ENGINEER OR AS SPECIFIED ON THE PLANS.

7-25-2022


DRAWING TITLE: ROADWAY LIGHTING ESTIMATE OF QUANTITIES AND NOTES

HORIZONTAL SCALE SCALE: N/A


02-0935.00 HENDERSON SHEET NO.

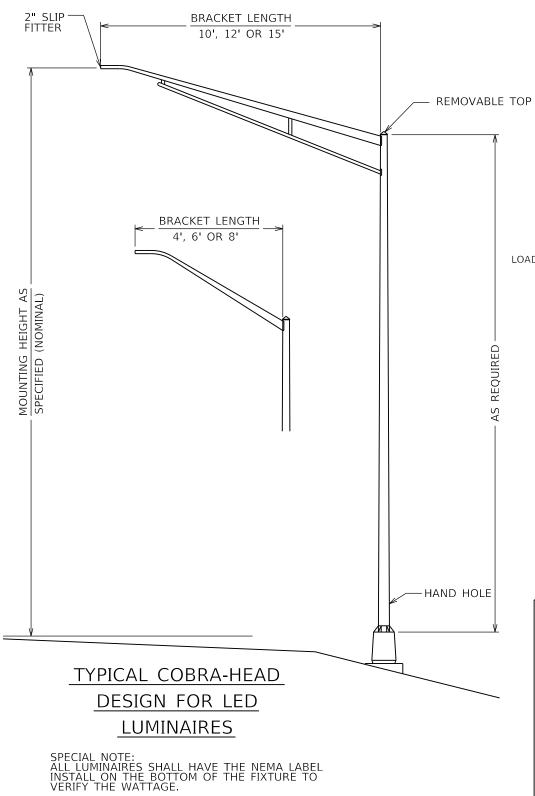


# BREAKAWAY FUSE CONNECTOR KIT

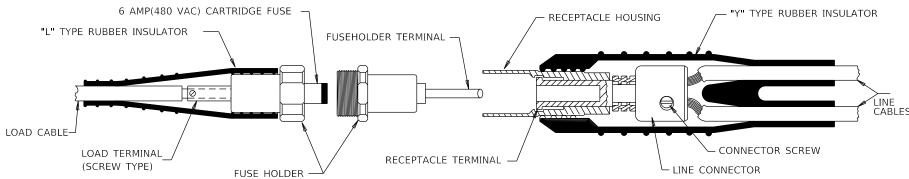

## DETAILS OF TYPE HEB-JW-RYC CONNECTOR

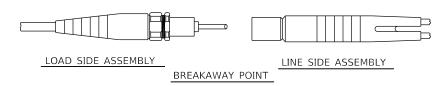

TYPE HEB-JW-RYC CONNECTOR SHOWN

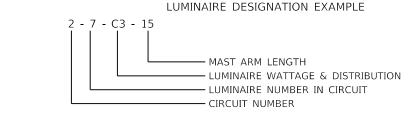

NOTE: IF NO SETBACK DIMENSION IS INDICATED, THE MAST ARM LENGTH DENOTES THE DISTANCE FROM THE RIGHT EDGE OF PAVEMENT TO CENTER OF POLE BASE.

NOTE:

ALL TYPE C LUMINAIRES ARE MOUNTED AT 40' (NOMINAL) LED EQUIVALENT TO 250 WATTS HPS.

ALL TYPE C LUMINAIRES HAVE A ROADWAY TYPE 3 LIGHT DISTRIBUTION.


4-24-2017

COMMONWEALTH OF KENTUCKY DEPARTMENT OF HIGHWAYS

DRAWING TITLE: COBRAHEAD MOUNTING AND FUSE CONNECTOR DETAILS

HORIZONTAL SCALE SCALE: N/A ITEM NO. COUNTY OF HENDERSON

SHEET NO. T2

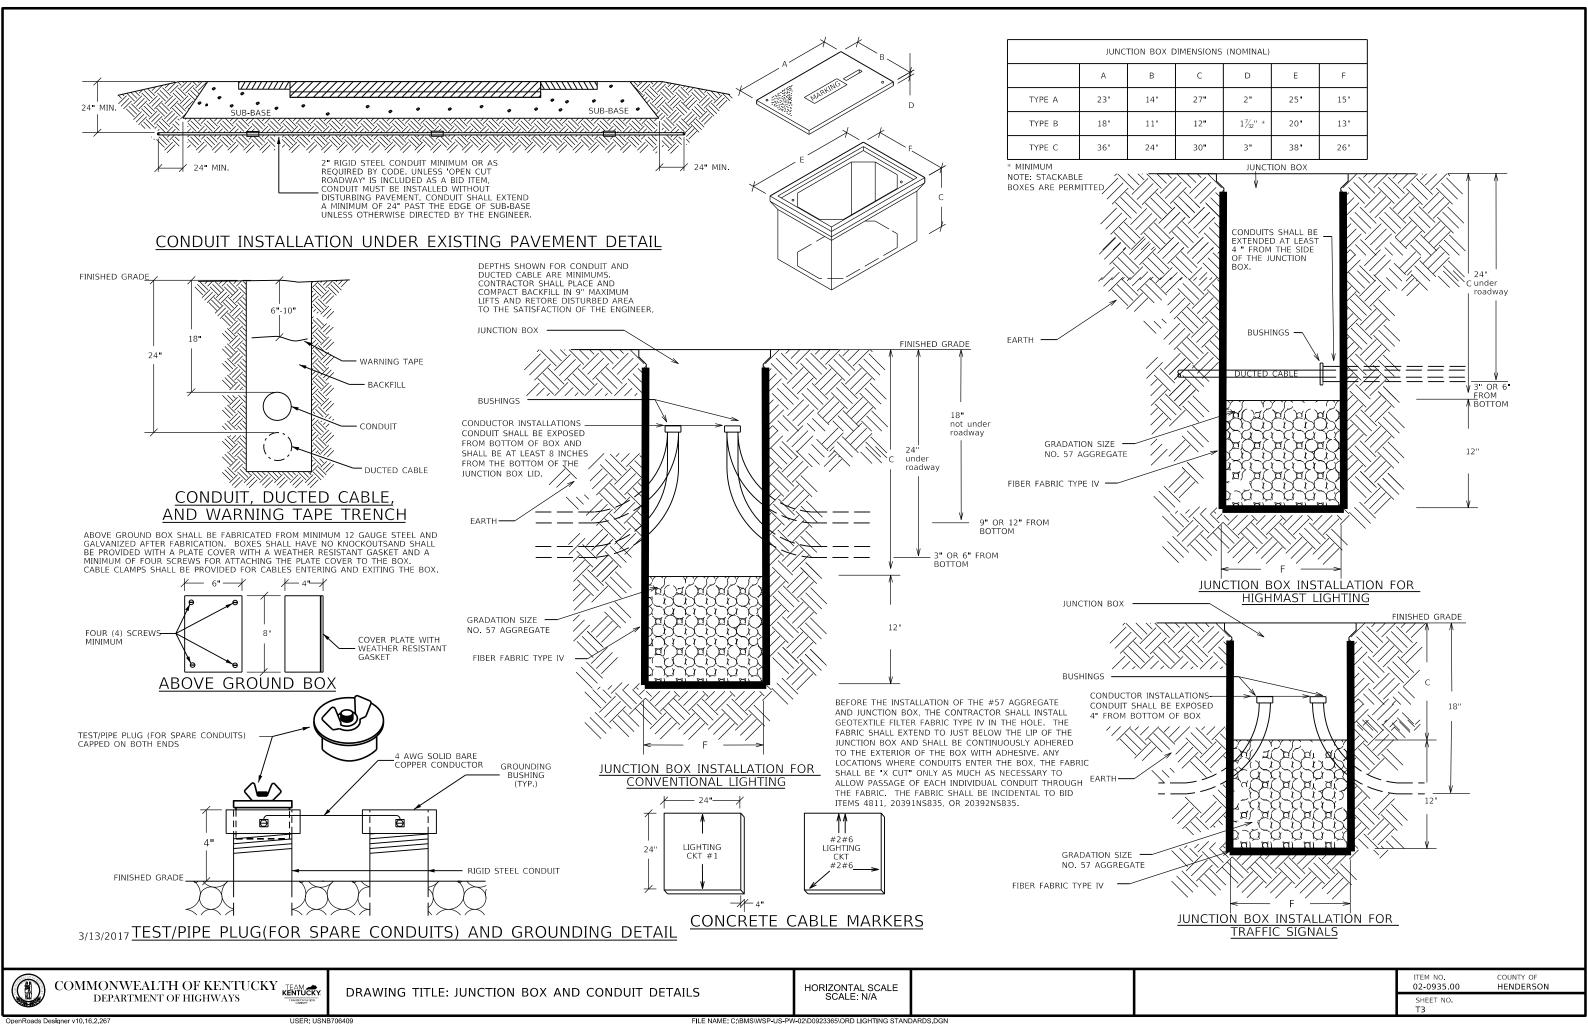

## DESIGN CRITERIA FOR LED MONGOOSE STYLE LUMINAIRE

LIGHTING CRITERIA FOR SOUTHERN U-TURN CONFLICT AREA ILLUMINANCE: AVERAGE: NOT LESS THAN .57 FOOTCANDLES AND MORE THAN 85 FOOTCANDLES MINIMUM: NOT LESS THAN 20 FOOTCANDLES AVERAGE/MINIMUM: NOT MORE THAN 3.5:1

ALL POLE LOCATIONS, ARM LENGTHS, AND ORIENTATION OF LUMINAIRE (TO CURVE/ROAD) SHOULD BE MAINTAINED DUE TO UTILITIES/DRAINAGE/RIGHT-OF-WAY.

LIGHTING CRITERIA FOR SOUTHERN U-TURN CONFLICT AREA ILLUMINANCE: AVERAGE: NOT LESS THAN .57 FOOTCANDLES AND MORE THAN .85 FOOTCANDLES MINIMUM: NOT LESS THAN .20 FOOTCANDLES AVERAGE/MINIMUM: NOT MORE THAN 3.5:1

ALL POLE LOCATIONS, ARM LENGTHS, AND ORIENTATION OF LUMINAIRE (TO CURVE/ROAD) SHOULD BE MAINTAINED DUE TO UTILITIES/DRAINAGE/RIGHT-OF-WAY.

#### LUMINAIRE DESIGN:


#### MONGOOSE LUMINAIRES

DRIVER: NOT TO EXCEED 700 mA DISTRIBUTION: MEDIUM ROADWAY LAMP WATTAGE: CAN NOT **EXCEED 120 WATTS** 

## COBRAHEAD LUMINAIRES

DRIVER: NOT TO EXCEED 700 mA DISTRIBUTION: ROADWAY TYPE 2 LAMP WATTAGE: CAN NOT EXCEED 120 WATTS

#### LUMINAIRE DESIGNATION EXAMPLE

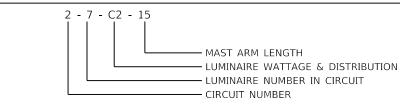

NOTE: IF NO SETBACK DIMENSION IS INDICATED, THE MAST ARM LENGTH DENOTES THE DISTANCE FROM THE RIGHT EDGE OF PAVEMENT TO CENTER OF POLE BASE.

NOTE:

ALL MONGOOSE LUMINAIRES ARE MOUNTED AT 40' (NOMINAL) LED EQUIVALENT TO 250 WATTS HPS. ALL MONGOOSE LUMINAIRES HAVE A MEDIUM ROADWAY (TYPE 2) LIGHT DISTRIBUTION.

The following are the required Specifications for the LED Fixture:

The Luminaire shall be listed by a National Recognized Testing Laboratory (NRTL) as defined by the U.S. Department of Labor. The testing laboratory must be listed by OSHA in its scope of recognition for the applicable tests being conducted as required by this specification. A list of recognized testing labs for products sold in the United States may be found on the U.S. Department of Labor's web site: http://www.osha.gov/

2. The Luminaire shall be listed and labeled by a NRTL or CSA as being in compliance with UL 1598 and suitable for use in wet locations. Key components including LED drivers, LED light sources, and surge

protection devices shall be RoHS compliant.

The housing shall have an International Electrotechnical Commission (IEC) 529 Ingress Protection (IP) rating of IP 65 or greater.

Shall be in compliance with Electro Magnetic Interference (EMI) requirements as defined by FCC 47 Sub Part 15; CISPR15, CISPR22 Class A (120Vmin), EN61000-3-2, -3-3, -4-4, -4-5.

6. Shall be tested according to the most current version of Illuminating Engineering Society of North America (IESNA) LM-79.

Shall have lumen maintenance measured in accordance the most current version of Illuminating Engineering Society of North America (IESNA) LM-80.

Shall have long term lumen maintenance documented according to the most current version of Illuminating Engineering Society of North America (IESNA) TM-

The fixture shall have a diecast aluminum housing.
The luminaire finish shall be corrosion resistant with a polyester powdercoat of 2.5 mil nominal thickness. Finish shall pass per ASTM D1654 after 3000 hours of testing per ASTM B117.

11. All hardware on the exterior of the housing including cover and latch shall be stainless steel, zinc or steel with zinc alloy electroplate and chromate top coat .

12. The luminaire shall be easy to open when properly mounted and shall have readily accessible internal parts. Access to all internal parts requiring replacement shall not require tools (i.e. "tool-less entry").

The luminaire shall have a vibration rating of 3G per the American National Standard (ANSI) IEEE C136.31, Table 2 Roadway Lighting Equipment -Luminaire Vibration for both normal applications and bridge and overpass applications.

The luminaire shall be designed to allow water shedding

The luminaire shall have a passive cooling method shall be employed to manage thermal output of LED light engine and power supply.

16. The luminaire shall have a label per ANSI C136.22 that states operating voltage and current range. The label must be clearly visible on the inside of the housing.

17. The luminaire shall fully operate in a temperature range of -40 degrees C up to 40 degrees C (-40 degrees F to 104 degrees F).

18. In retrofit applications, the LED luminaire shall not be more wattage than the original HPS fixture if you are replacing one for one. For the optimized proposal, we will allow the wattage to be greater than the original proposed luminaire.

19. The luminaire shall have an integral power supply (electronic driver). The power supply shall not have a manual, field-adjustable setting for current

20. The luminaire shall have a power supply (electronic driver) that will operate on a 480 volt single phase at 60 hertz.

21. The luminaire shall have a power supply (electronic driver) that has a

power factor of .90 or greater at full load.

22. The luminaire shall have a power supply (electronic driver) that has total harmonic distortion of 20% or less at full load.

The luminaire shall have power supply (electronic driver) output ripple of

24. The luminaire shall have power supply (electronic driver) with a rated life of 100,000 hours with a luminaire operated at an ambient temperature of 25^C (

25. The luminaire shall have an isolated power supply (electronic driver) output.

26. The luminaire shall have a power supply (electronic driver) that has thermal overload protection.

27. The luminaire shall have a power supply (electronic driver) that is selflimited short circuit protected and over load protected.

28. The luminaire shall not use any active thermal cutback, such as in order to achieve a higher thermal performance.

29. The luminaire shall have a power supply (electronic driver) that is terminated with quick disconnect wire harnesses for easy maintenance. Wire nut termination is not acceptable.

30. The luminaire shall have a terminal block for terminating wiring to the luminaire. The terminal block shall be a 3 station, tunnel lug terminal board that will accommodate #6 thru #18 AWG pole wire.

31. Fixture shall have a surge protection that meets 10KV/5KA per

The luminaire shall have life rating on all electrical components of 100,000 hours or greater when operated at full lumen output at 25 degrees C. 33. All LED components shall be L70 rated when operated in a luminaire at 25

degrees C (77 degrees F) at 100,000 hours.

37. The LED shall have a rated life of 100,000 hours when operated at 40 ^C. 38. The LED shall have a minimum Luminaire efficacy of 120 lumens/watt. 39. The Correlated Color Temperature (CCT) shall be 4000K with a variance of 250K, white, that conforms to LM-79. The Correlated Color Temperature (CCT) shall be 5000K with a variance of 250K, white, that conforms to LM-79 (HIGH

40. The minimum color rendering index (CRI) shall not be less than 70.
41. The optics shall have a completely sealed optical system.
42. The optical system shall have a (IEC) (IP) rating of 66 or greater.
43. The optics shall have an Illuminating Engineering Society of North America (IESNA) Backlight, Uplight and Glare (BUG) rating as follows:

Backlight rating shall not exceed 3;(highmast fixture backlight rating shall not exceed 5)

Uplight rating shall not exceed 0; Glare rating shall not exceed 3/4 The Light Loss Factor (LLF) shall be calculated for each fixture as

ILE = ILD X IDD

Lamp Lumen Depreciation Factor (LLD) shall be the specified percentage of LED lumen maintenance at 70,000 hours at 25°C (77°F) from the TM-21 report. This LLD should be according to LM -80 and TM -21 reports. This report shall be submitted for verification

Luminaire Dirt Depreciation (LDD)= .9
45. The TM-21 Report must show the drive current used for the submitted luminaire. The report can show a larger drive current to represent a worst case

The Lumen Maintenance Life L80 from the TM-21 Report must not be below 80% 70,000 hours at 25^C (77^F).

The manufacturer shall provide certified test laboratories IES photometrics which verify light levels. Product submittal shall be accompanied by IES TM-21 compliant test reports from a CALIPER qualified or NVLAP accredited testing

laboratory for the specific model being submitted.
48. The luminaire shall be equipped with a shorting cap and a 7-pin photocontrol receptacle that meets ANSI 2013 standard C136.41

49. The luminaire shall have an exterior label the identifies the fixture type (A,B,C,D) and the distribution type. This label shall be submitted and

approved by the project enginéer.

50. The luminaire shall have a QR code label that can be scanned and identify the model number and serial number for each individual fixture. This label

shall be submitted and approved by the project engineer.

Shall be submitted and approved by the project engineer.

WARRANTY: The Manufacturer shall ensure that the LED Luminaires have a minimum standard warranty of 10 years for all parts, materials, paint finish, and shipping (both ways) required to repair or replace the luminaire. The warranty shall begin upon the date the luminaire is received. The warranty shall be transferable. Technical Support. During the warranty period, technical support shall be available from the manufacturer via telephone within 24 hours of the time the call is made from KYTC, and this support shall be made available from factory certified personnel or factory certified installers at

no additional charge to the Department. 52. MINIMUM REQUIRED SUBMITTALS:

Luminaire specification sheet. LED driver specification sheet


LM-79 Luminaire photometric report. The vendor must submit LM-79 in-situ test data to confirm thermal operating temperatures of the luminaire. LM-80 Lumen maintenance report.

TM-21 calculations as defined

Backlight, Uplight, Glare (BUG) rating of the luminaire. Written product warranty.
Certified test lab IES photometric reports.
Including IES electronic file.

Including intensity and chromaticity data.

Instructions for installation and maintenance.

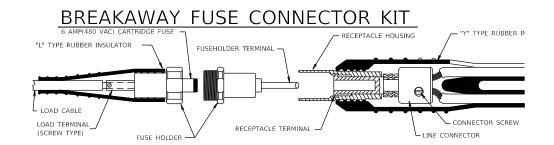




DRAWING TITLE: HIGH MAST LUMINAIRE DETAILS


HORIZONTAL SCALE SCALE: N/A

02-0935.00 HENDERSON SHEET NO.

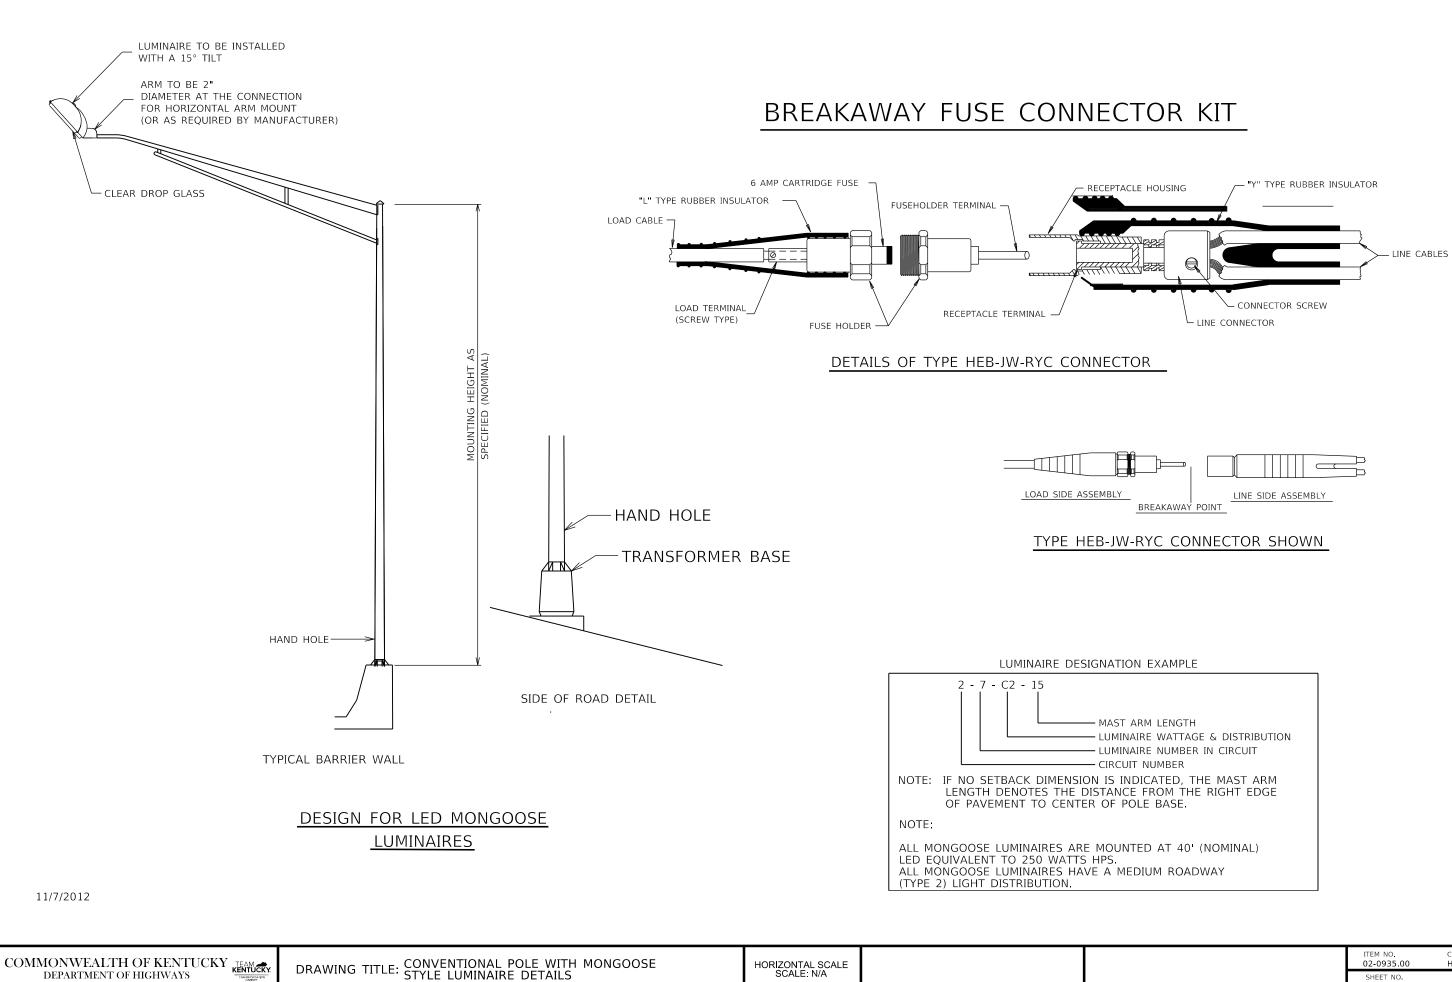

DEPARTMENT OF HIGHWAYS

FILE NAME: C:\BMS\WSP-US-PW-02\D0923365\ORD LIGHTING STANDARDS.DGN

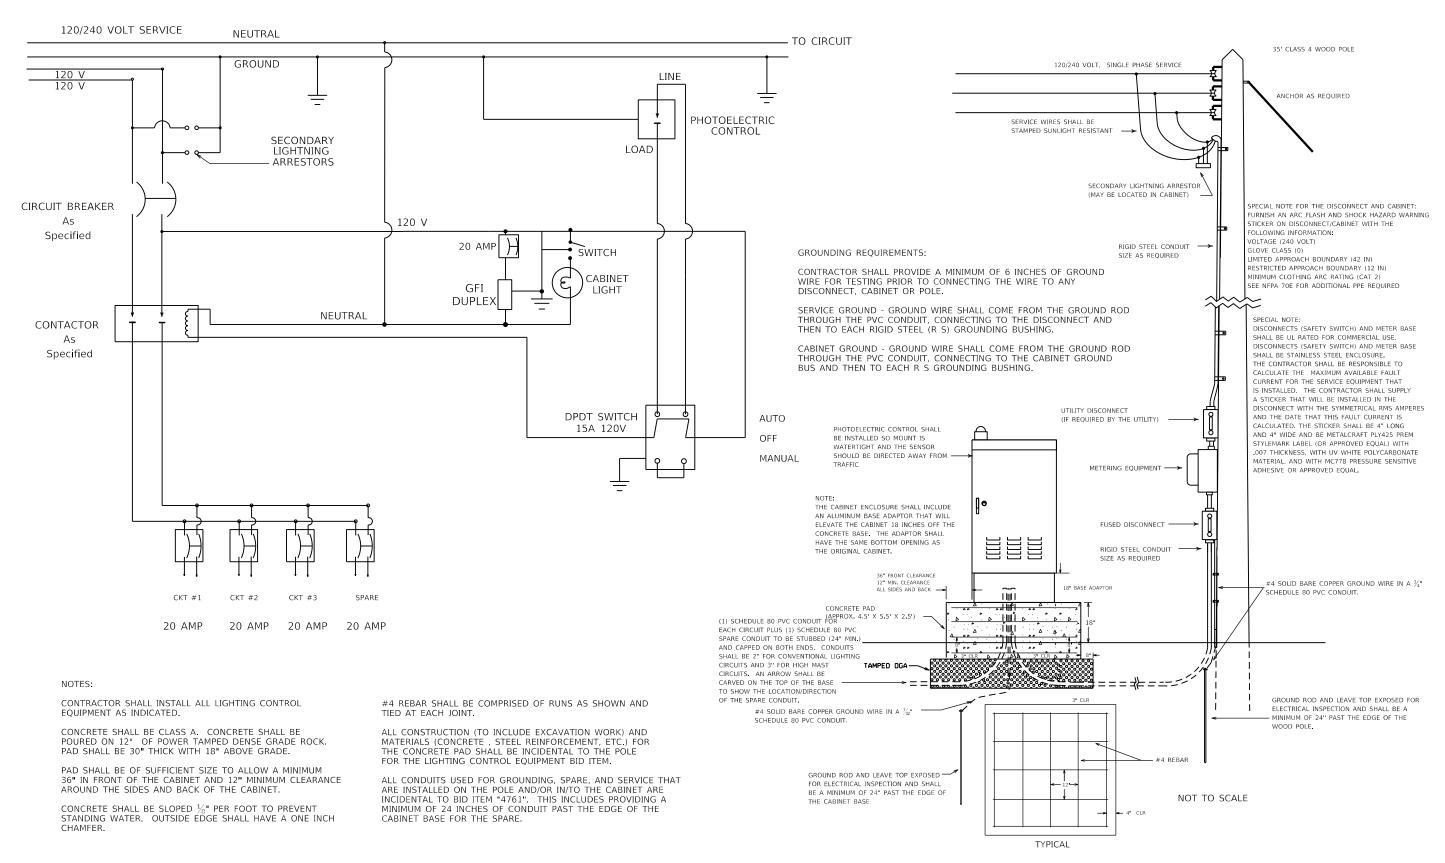


1/24/2020

OpenRoads Designer v10.16.2.267

DRAWING TITLE: BASE MOUNTED LIGHTING CONTROL CABINET DETAILS, 120V/240V

HORIZONTAL SCALE SCALE: N/A

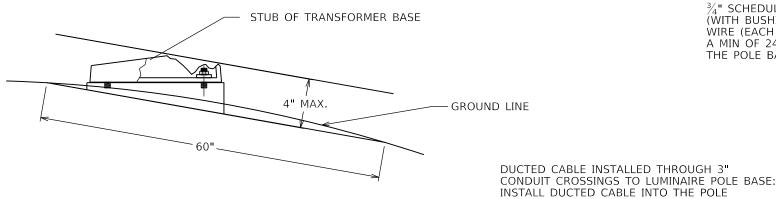

THE ANCHOR BOLTS AND CONDUITS SHALL NOT BE PROJECTED MORE 4 INCHES ABOVE A GROUND LINE BETWEEN THE STRADDLING WHEELS OF A VEHICLE.

3/4" SCHEDULE 80 PVC CONDUIT (WITH BUSHING) FOR GROUND WIRE (EACH BASE) AND SHALL BE A MIN OF 24" FROM THE EDGE OF THE POLE BASE.

**GROUND LINE** 6" MIN. BRONZE GROUND CLAMP g" X 8' COPPERWELD GROUND ROD AND SHALL BE A MINIMUM OF 48" FROM #4 A.W.G. SOLID THE EDGE OF POLE BASE. COPPER GROUND WIRE **GROUNDING DETAIL** 

CONNECTING BOLT

SPACER PLATES SHALL BE USED TO


## BREAKAWAY SUPPORT STUB HEIGHT MEASUREMENT

IF DUCTED CABLE INSTALLED BETWEEN POLE BASES: INSTALL RIGID STEEL/DUCTED CABLE COUPLING. USE BONDUIT CONDUIT ADHESIVE OR APPROVED EQUAL TO CONNECT THE RIGID STEEL TO DUCTED CABLE. RACEWAYS SHALL BE THE SAME SIZE AS THE DUCTED CABLE WHICH ATTACHS TO THE RIGID STEEL CONDUIT. ALTERNATELY IF DUCTED CABLE IS USED, THE CONTRACTOR CAN INSTALL RIGID STEEL CONDUIT TWO TIMES THE SIZE OF THE DUCT AND RUN THE DUCT INSIDE THIS CONDUIT. THE SWEEP FOR THE CONDUIT SHALL BE INCREASED TO ADHERE TO THE BENDING RADIUS RECOMMENDED BY THE MANUFACTURER OF THE DUCT.

GROUNDING BUSHINGS #4 SOLID BARE COPPER WIRE TO GROUND LUG FROM GROUND LUG < IN TRANSFORMER IN TRANSFORMER BASE OR POLE BASE OR POLE SHAFT " SCHEDULE 80 PVC CONDUIT (WITH BUSHING) FOR GROUND WIRE (EACH BASE) TO GROUND ROD RIGID CONDUIT

# TYPICAL GROUNDING DETAIL

ACCEPTABLE

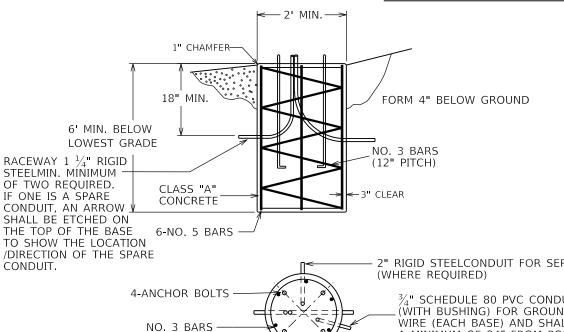

2" RIGID STEELCONDUIT FOR SERVICE  $rac{1}{4}$ " SCHEDULE 80 PVC CONDUIT (WITH BUSHING) FOR GROUND WIRE (EACH BASE) AND SHALL BE A MINIMUM OF 24" FROM POLE BASE. ALL POLE BASES SHALL HAVE A MINIMUM OF TWO CONDUITS (NOT INCLUDING GROUND 6-NO. 5 BARS CONDUIT). THE SPARE CONDUIT SHALL BE NOTE: PRECAST CONCRETE 180 DEGREE FROM THE CONDUIT FOR THE BASES ARE NOT

GROUNDING REQUIREMENTS:

BASE. THE DUCT SHOULD BE EXTENDED 1" ABOVE THE CONDUIT. THE CONDUIT SWEEP

MANUFACTURER OF THE DUCTED CABLE TO

PREVENT THE DUCTED CABLE FROM CRIMPING.

SHOULD BE INSTALL ACCORDING TO THE

CONTRACTOR SHALL PROVIDE A MINIMUM OF 6 INCHES OF GROUND WIRE FOR TESTING PRIOR TO CONNECTING THE WIRE TO TRANSFORMER BASE.

POLE/TRANSFORMER BASE GROUND - GROUND WIRE SHALL COME FROM THE GROUND ROD THROUGH THE PVC CONDUIT, CONNECTING TO THE TRANSFORMER BASE/POLE AND THEN TO EACH RIGID STEEL GROUNDING BUSHING.

#### NOTES:

ALL CONDUITS USED FOR THE GROUNDING, SPARES AND CONDUCTORS THAT ARE INSTALLED IN THE POLE BASE ARE INCIDENTAL TO BID ITEM "4740". THIS INCLUDES PROVIDING A MINIMUM OF 24 INCHES OF CONDUIT PAST THE EDGE OF THE THE TRANSFORMER BASE DOOR SHALL HAVE POLE BASE.

PREVENT OPENINGS ON TOP OF BASE. THEFT DETTERENT DOOR OPENING (LOCATE DOOR ON SIDE AWAY FROM ON-COMING TRAFFIC) 17" MIN. GROUNDING NUT OR LUG ON BASE FLANGE PLATE STEEL PLATES (4) -15" MIN.-

CONCRETE BASES SHALL BE POURED LEVEL NO MORE THAN A .375" GAP SHALL EXIST BETWEEN CONCRETE BASE AND TRANSFORMER BASE WHEN THE POLE IS PLUMBED. **TYPICAL** 

## CAST ALUMINUM TRANSFORMER BASE

A 4" BY 6" ARC FLASH WARNING STICKER INSTALL 3" FROM THE TOP OF THE DOOR. THE STICKER SHALL BE METALCRAFT PLY695 PREM STYLEMARK LABEL WITH .007 THICKNESS, WITH UV WHITE POLYCARBINATE MATERIAL, AND WITH MC53FL PRESSURE SENSTIVE ADHESIVE OR APPROVAL EQUAL. THIS SHALL BE INCIDENTAL TO PROJECT.

-12" MIN -

SPECIAL NOTE FOR TRANSFORMER BASES: FURNISH AN ARC FLASH AND SHOCK HAZARD WARNING STICKER ON TRANSFORMER BASE WITH THE FOLLOWING INFORMATION: VOLTAGE (480 VOLT) GLOVE CLASS (0) LIMITED APPROACH BOUNDARY (42 IN) RESTRICTED APPROACH BOUNDARY (12 IN) MINIMUM CLOTHING ARC RATING (CAT 2) SEE NFPA 70E FOR ADDITIONAL PPE REQUIRED

# FOUNDATION DETAIL

COMMONWEALTH OF KENTUCKY DEPARTMENT OF HIGHWAYS


CONDUCTORS.


1/30/2020

DRAWING TITLE: TRANSFORMER BASE DETAILS

HORIZONTAL SCALE SCALE: N/A

02-0935.00 HENDERSON SHEET NO.

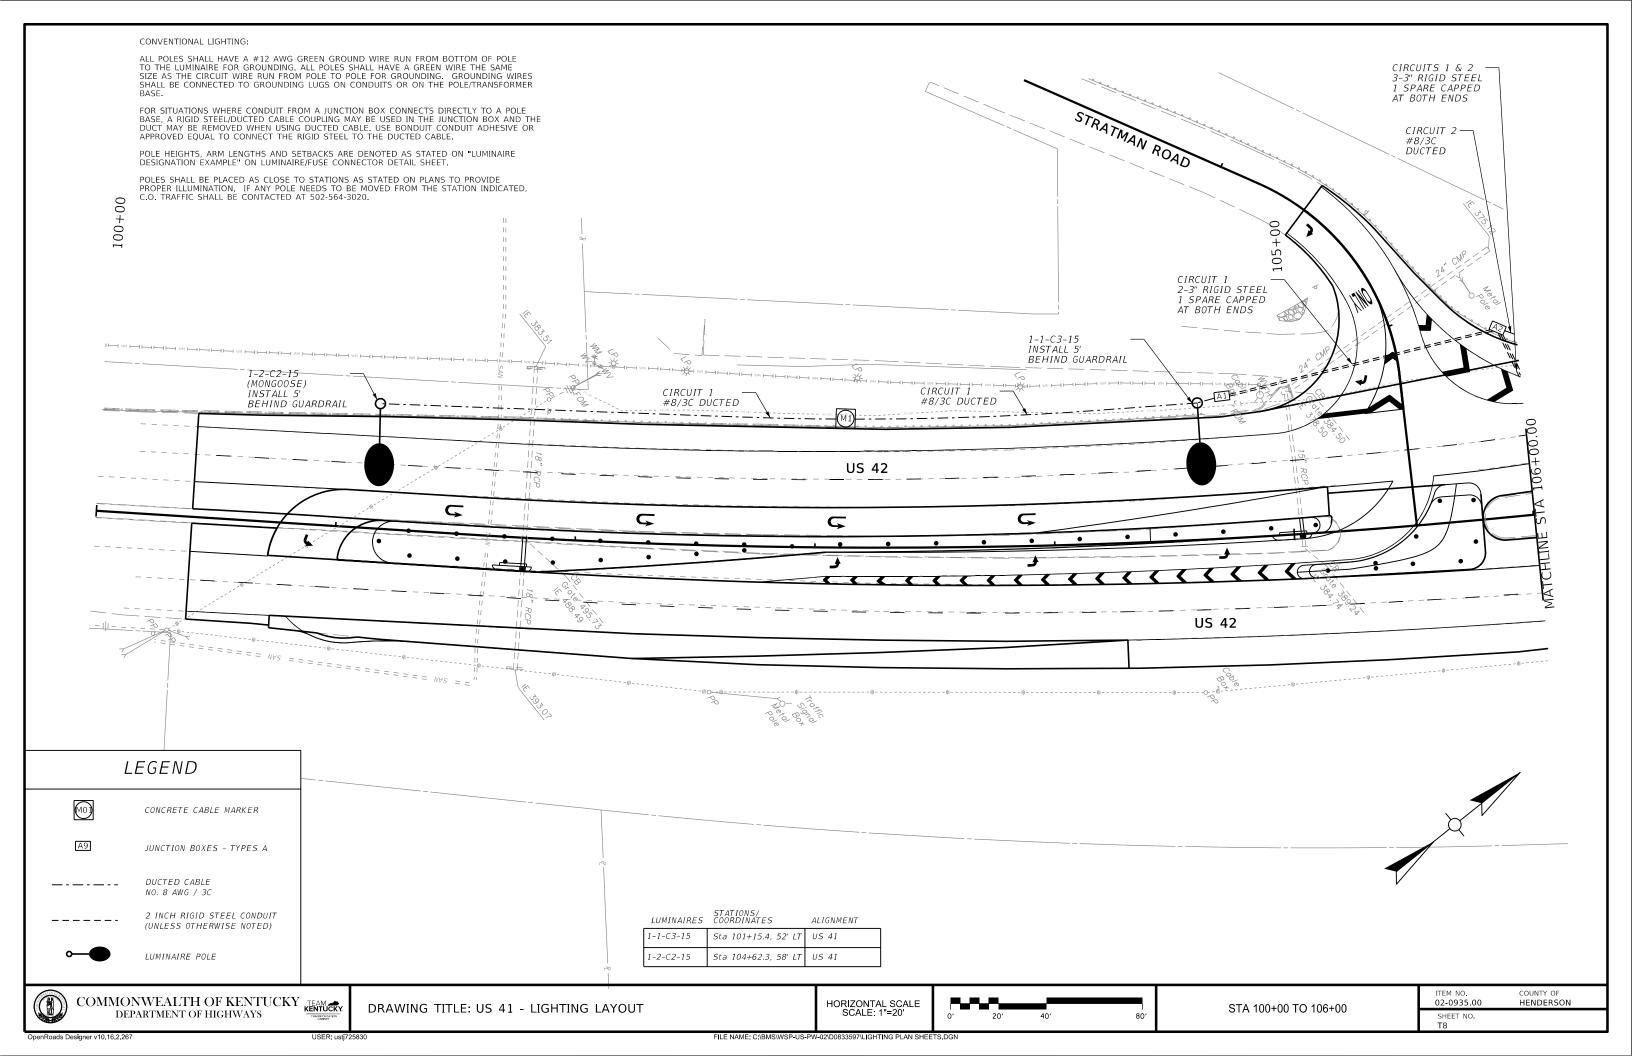

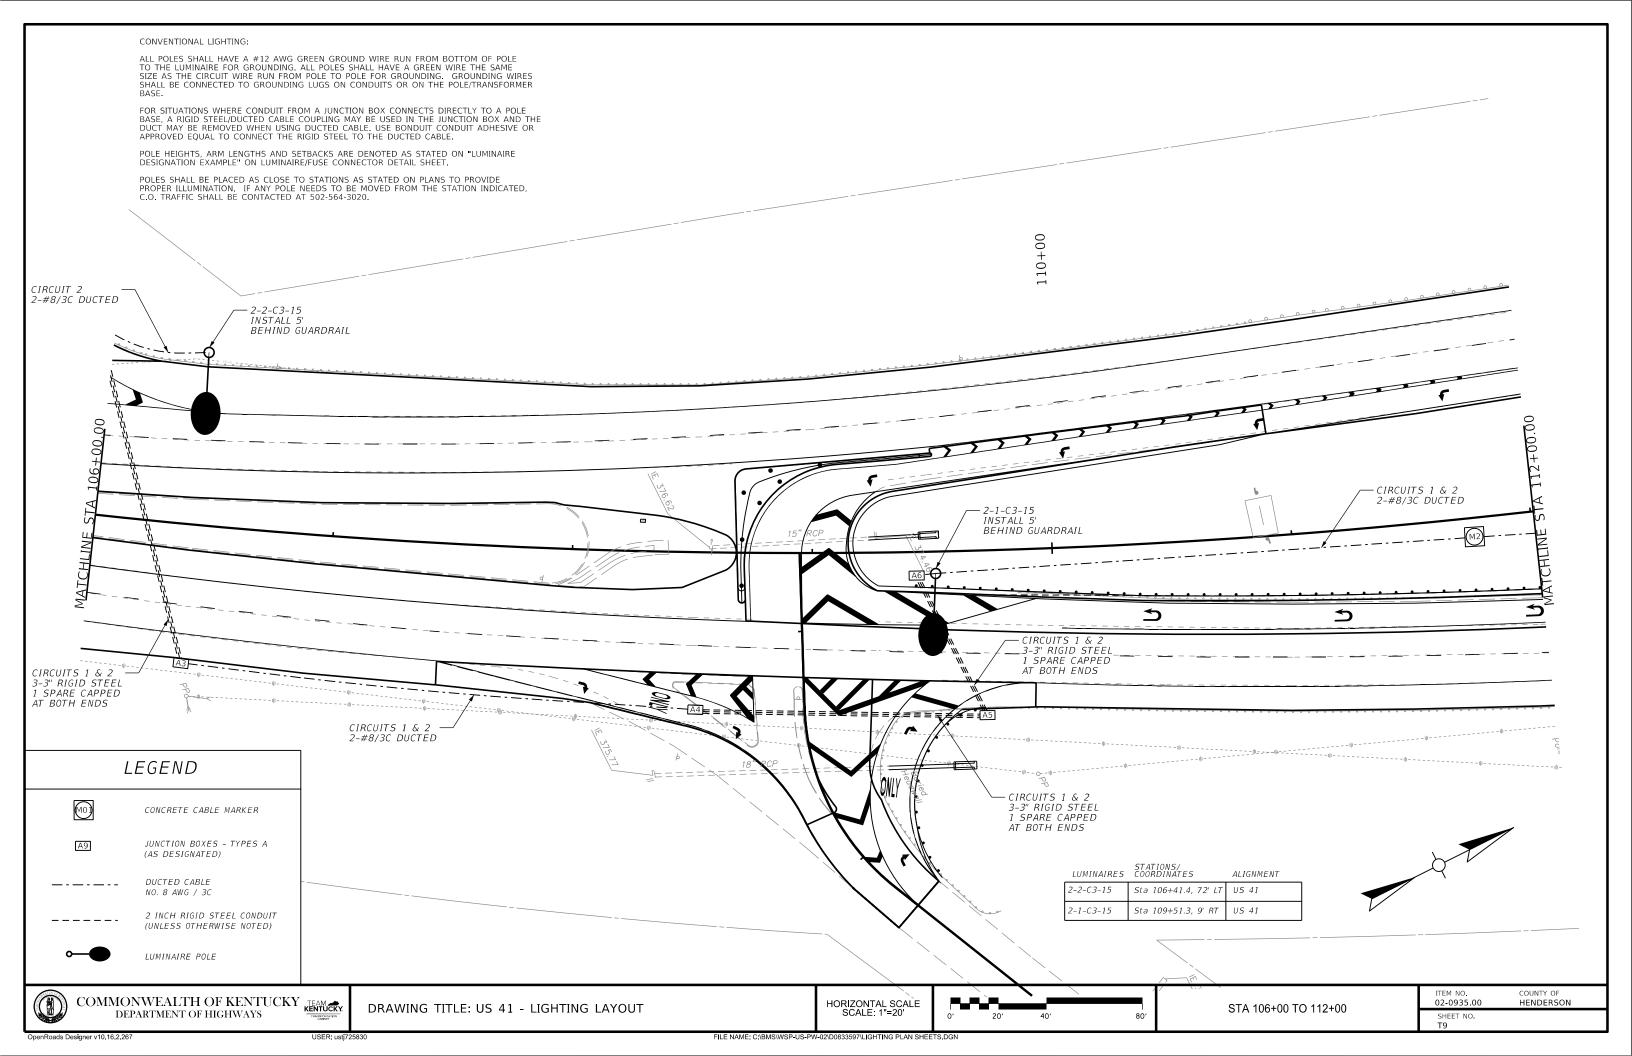

# CONVENTIONAL LIGHTING:


ALL POLES SHALL HAVE A #12 AWG GREEN GROUND WIRE RUN FROM BOTTOM OF POLE TO THE LUMINAIRE FOR GROUNDING. ALL POLES SHALL HAVE A GREEN WIRE THE SAME SIZE AS THE CIRCUIT WIRE RUN FROM POLE TO POLE FOR GROUNDING. GROUNDING WIRES SHALL BE CONNECTED TO GROUNDING LUGS ON CONDUITS OR ON THE POLE/TRANSFORMER


FOR SITUATIONS WHERE CONDUIT FROM A JUNCTION BOX CONNECTS DIRECTY TO A POLE BASE, A RIGID STEEL/DUCTED CABLE COUPLING MAY BE USED IN THE JUNCTION BOX AND THE DUCT MAY BE REMOVED WHEN USING DUCTED CABLE. USE BONDUIT CONDUIT ADHESIVE OR APPROVED EQUAL TO CONNECT THE RIGID STEEL TO DUCTED CABLE.

POLE HEIGHTS, ARM LENGTHS AND SETBACKS ARE DENOTED AS STATED ON "LUMINAIRE DESIGNATION EXAMPLE" ON LUMINAIRE/FUSE CONNECTOR DETAIL SHEET.

POLES SHALL BE PLACED AS CLOSE TO STATIONS AS STATED ON PLANS TO PROVIDE PROPER ILLUMINATION. IF ANY POLE NEEDS TO BE MOVED FROM THE STATION INDICATED, C.O. TRAFFIC SHALL BE CONTACTED AT 502-564-3020.

## WIRING SCHEDULE

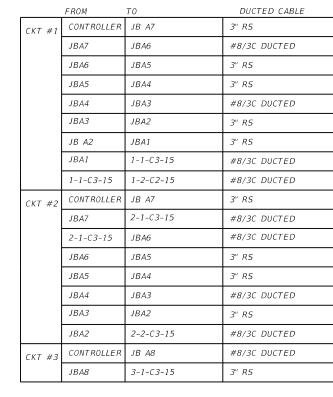

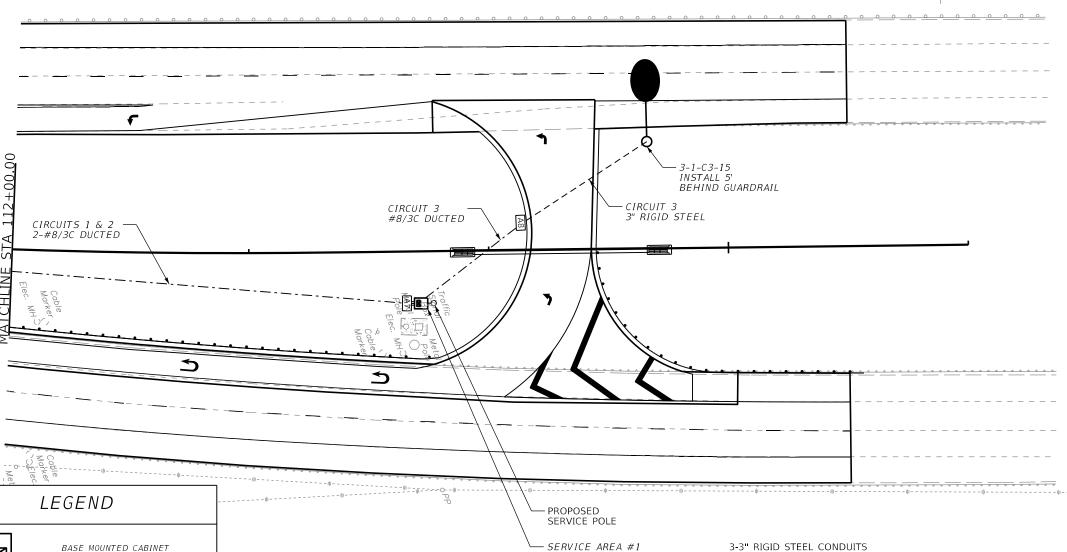





JUNCTION BOXES - TYPES A (AS DESIGNATED)



2 INCH RIGID STEEL CONDUIT (UNLESS OTHERWISE NOTED)



OpenRoads Designer v10.16.2.267

LUMINAIRE POLE

DUCTED CABLE NO. 8 AWG / 3C

SERVICE AREA #1 CIRCUITS 1, 2, & 3 120V, 1-PHASE (1) WOOD SERVICE POLE (1) DISCONNECT AFTER METER (1) BASE MOUNTED LIGHTING

CONTROLL CABINET

3-3" RIGID STEEL CONDUITS FROM CABINET TO JUNCTION BOX A7

1 - CIRCUIT 1, #8/3C DUCTED

1 - CIRCUIT 2, #8/3C DUCTED 1 - SPARE, CAPPED AT BOTH ENDS




GRADE AROUND PROPOSED CABINET BASE AS NEEDED TO PROVIDE A LEVEL GROUND 12" AROUND THE SIDES AND BACK OF THE CABINET AND 36" IN FRONT OF THE CABINET BASE. MATERIALS AND LABOR FOR GRADING IS INCIDENTAL TO BID ITEM, "LIGHTING CONTROL EQUIPMENT."


LUMINAIRES STATIONS/ COORDINATES

US 41 3-1-C3-15 Sta 114+66.5, 45' LT

COMMONWEALTH OF KENTUCKY KENTUCKY DEPARTMENT OF HIGHWAYS

DRAWING TITLE: US 41 - LIGHTING LAYOUT

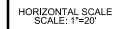


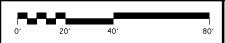



ALIGNMENT

ITEM NO.	COUNTY OF
02-0935.00	HENDERSON
SHEET NO. T10	

115+00

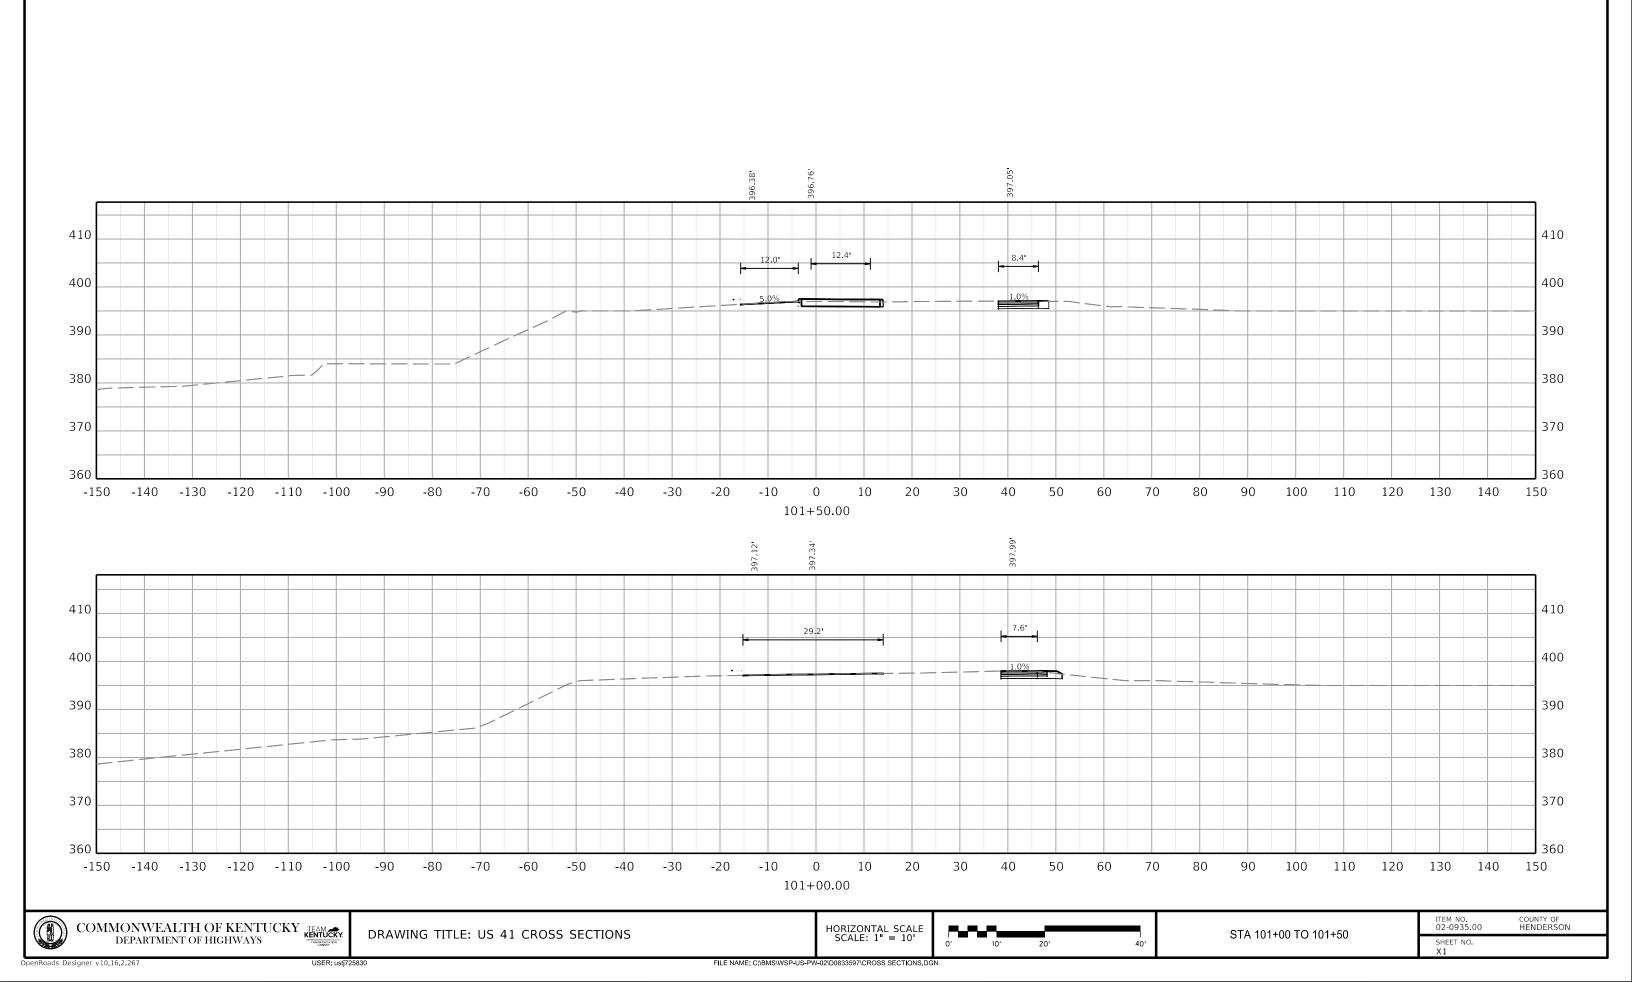

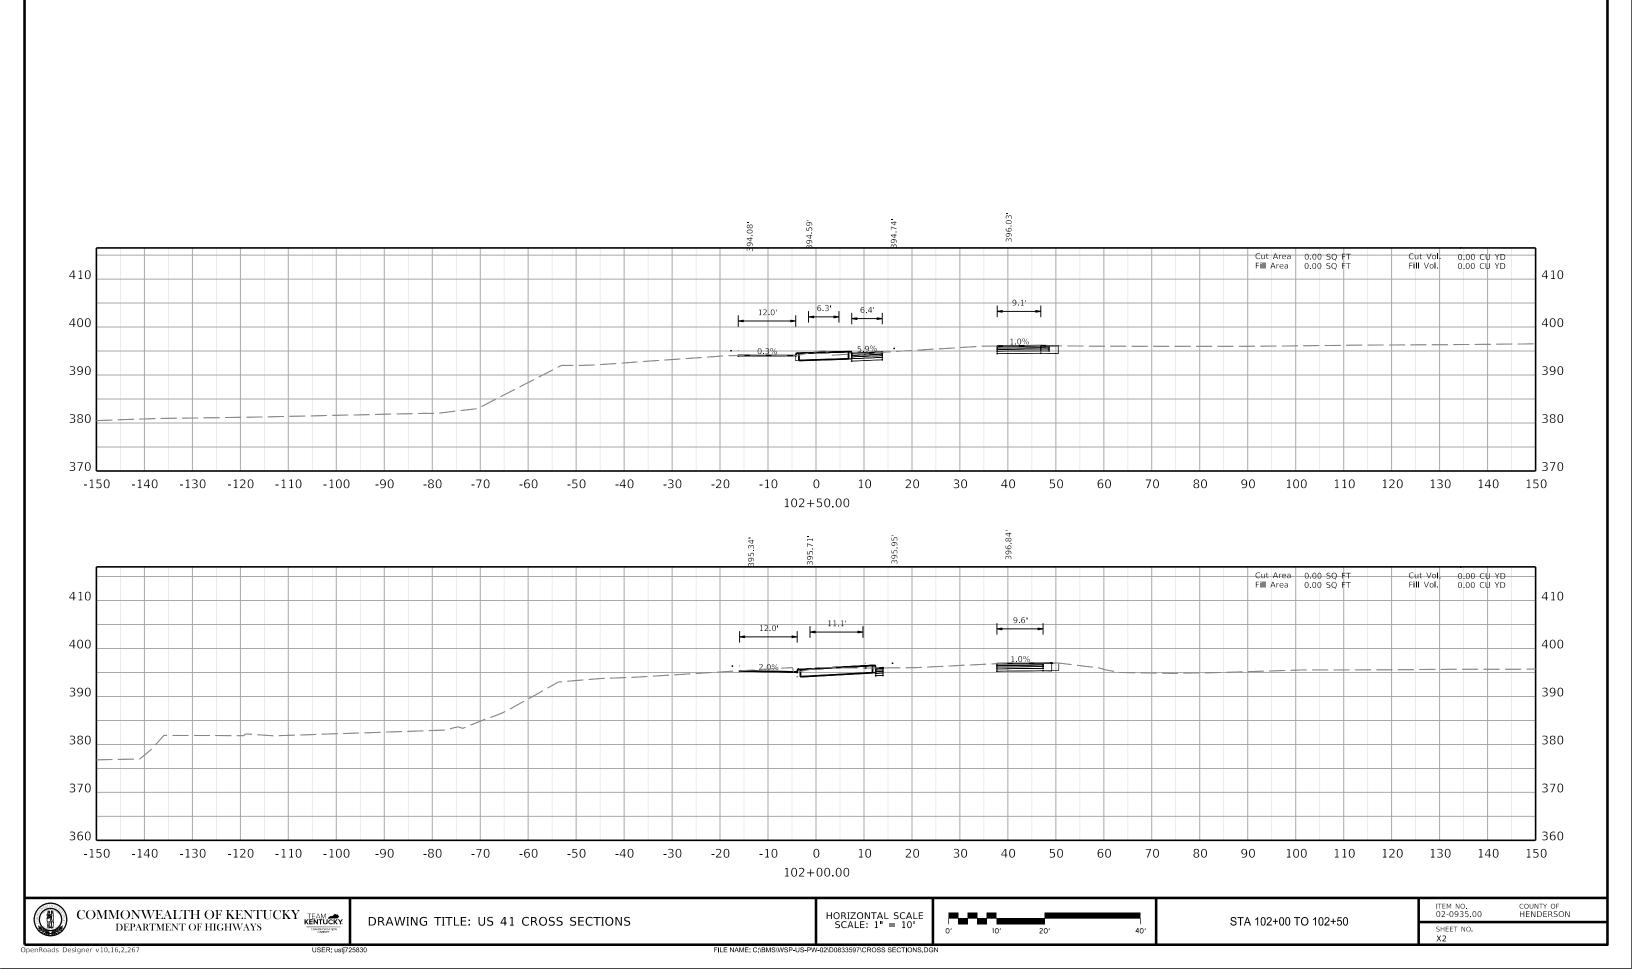

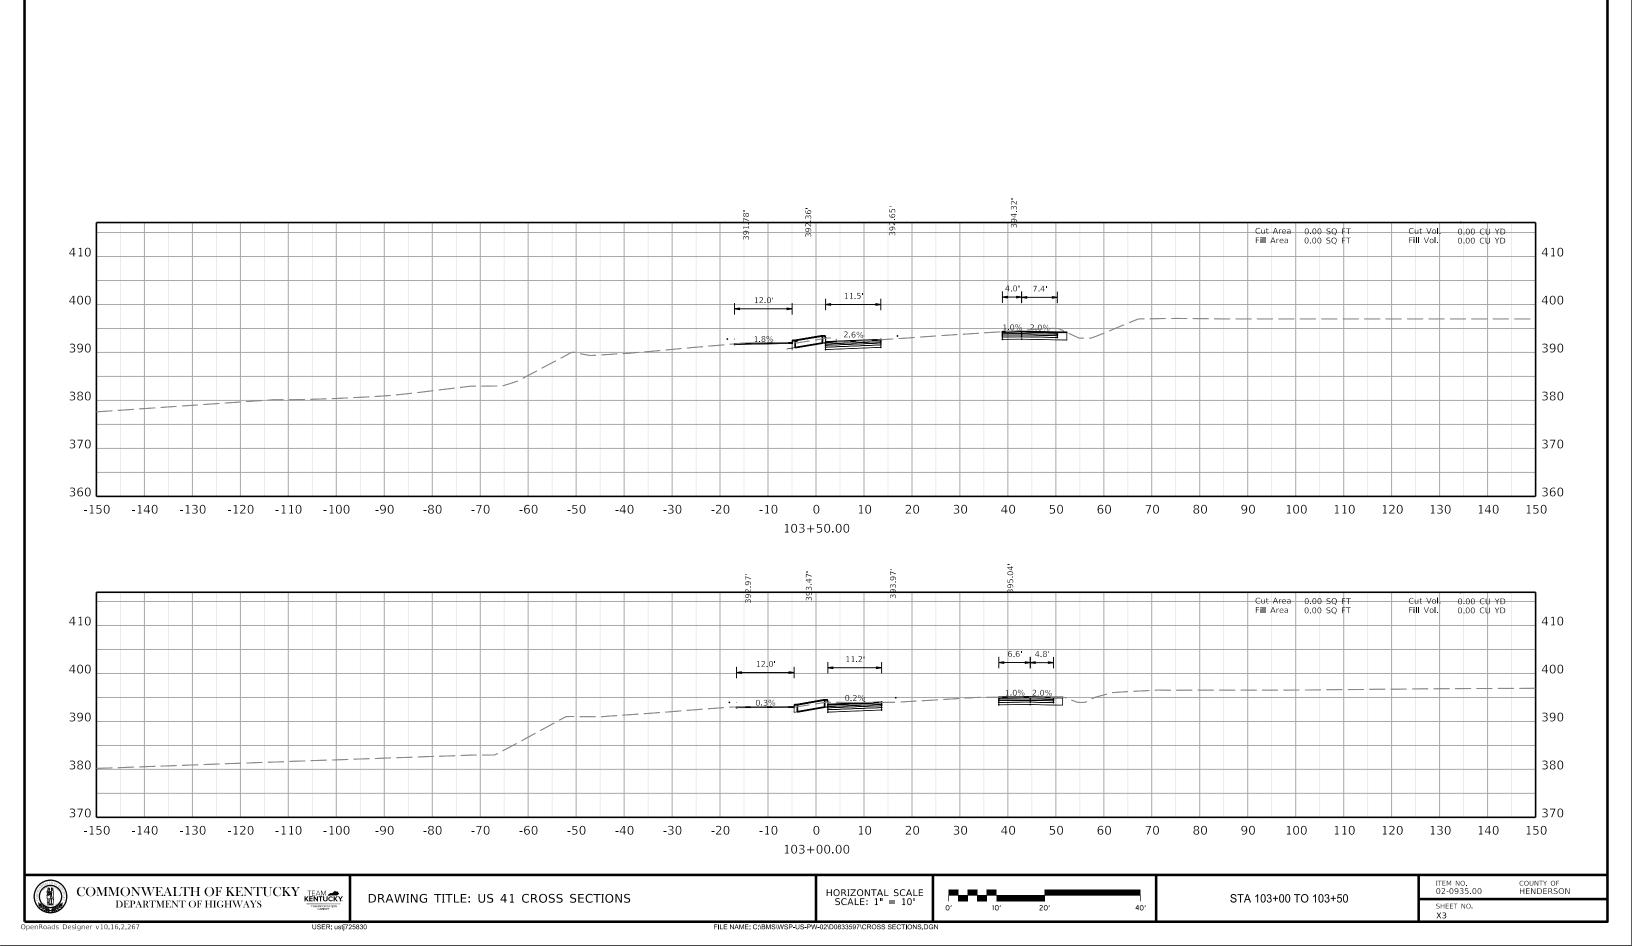

Cut Area 0.00 SQ FT Fill Area 0.00 SQ FT Cut Vol. 0.00 CU YD Fill Vol. 0.00 CU YD 410 410 400 400 12.0 390 390 380 380 370 370 360 -130 -120 -110 -100 -90 -80 -70 -60 -50 -40 -30 -20 -10 0 10 20 30 40 50 60 70 80 90 100 110 120 130 140 150 104+50.00 Cut Vol. 0.00 CU YD Fill Vol. 0.00 CU YD Cut Area 0.00 SQ FT Fill Area 0.00 SQ FT 410 410 10.1 400 400 390 390 380 380 370 370 360 -150 -140 -130 -120 -110 -100 -90 -80 -70 -60 -50 -40 -30 -20 -10 0 10 20 30 40 50 60 70 80 90 100 110 120 130 140 150 104+00.00 ITEM NO. 02-0935.00 COUNTY OF HENDERSON COMMONWEALTH OF KENTUCKY DEPARTMENT OF HIGHWAYS HORIZONTAL SCALE SCALE: 1" = 10' DRAWING TITLE: US 41 CROSS SECTIONS STA 104+00 TO 104+50 SHEET NO. FILE NAME: C:\BMS\WSP-US-PW-02\D0833597\CROSS SECTIONS.DGI

420 420 Cut Area 0.00 SQ FT Fill Area 0.00 SQ FT Cut Vol. Fill Vol. 0.00 CU YD 0.00 CU YD 410 410 400 400 390 390 380 380 370 370 -150 -140 -130 -120 -110 -100 -90 -80 -70 -60 -50 -40 -30 -20 -10 10 20 30 40 50 60 70 80 90 100 110 120 130 140 150 0 105+50.00 420 420 Cut Area 0.00 SQ FT Fill Area 0.00 SQ FT 0.00 CU YD 0.00 CU YD Cut Vol. Fill Vol. 410 410 400 400 12.0 390 390 380 380 370 370 360 -150 -140 -130 -120 -110 -100 -90 -80 -70 -60 -50 -40 -30 -20 -10 0 10 20 30 40 50 60 70 80 90 100 110 120 130 140 150 105+00.00 ITEM NO. 02-0935.00 COUNTY OF HENDERSON COMMONWEALTH OF KENTUCKY DEPARTMENT OF HIGHWAYS HORIZONTAL SCALE SCALE: 1" = 10' DRAWING TITLE: US 41 CROSS SECTIONS STA 105+00 TO 105+50 SHEET NO. X5 FILE NAME: C:\BMS\WSP-US-PW-02\D0833597\CROSS SECTIONS.DG

400 400 Cut Area 0.00 SQ FT Fill Area 0.00 SQ FT Cut Vol. 0.00 CÜ YD Fill Vol. 0.00 CÜ YD 390 390 20.9 380 380 370 370 360 360 350 -150 -140 -130 -120 -110 -100 -90 -80 -70 -60 -50 -40 -30 -20 -10 0 10 20 30 40 50 60 70 80 90 100 110 120 130 140 150 109+50.00 Cut Area 0.00 SQ FT Fill Area 0.00 SQ FT Cut Vol. Fill Vol. 400 400 390 390 380 380 370 370 360 360 350 -150 -140 -130 -120 -110 -100 -90 -80 -70 -60 -50 -40 -30 -20 -10 0 10 20 30 40 50 60 70 80 90 100 110 120 130 140 150 109+00.00 ITEM NO. 02-0935.00 COUNTY OF HENDERSON COMMONWEALTH OF KENTUCKY DEPARTMENT OF HIGHWAYS HORIZONTAL SCALE SCALE: 1" = 10' DRAWING TITLE: US 41 CROSS SECTIONS STA 109+00 TO 109+50 SHEET NO. FILE NAME: C:\BMS\WSP-US-PW-02\D0833597\CROSS SECTIONS.DG

